




REDUCED SCALE

Koomerang Ski Club Ensuite Alterations Site No. 180, Summit Road, Mt Buller

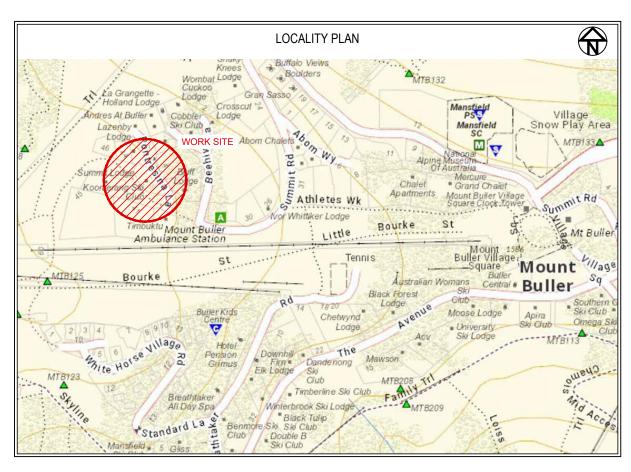




	DRAWING SCHEDULE	
DRAWING NUMBER	DRAWING TITLE	REVISION
GMR09001-24.3.01	Cover Sheet	
GMR09001-24.3.02	Existing Conditions	В
GMR09001-24.3.03	Existing Elevations	В
GMR09001-24.3.04	Existing Floor Plan - Ground Floor	В
GMR09001-24.3.05	Existing Floor Plan - First Floor	В
GMR09001-24.3-06	Existing Floor Plan - Second Floor	В
GMR09001-24.3.07 - 08	Existing Sections	В
GMR09001-24.3.09	Proposed Demolition Plan	E
GMR09001-24.3.10	Proposed Elevations	В
GMR09001-24.3.11	Proposed Floor Plan - Ground Floor	F
GMR09001-24.3.12	Proposed Floor Plan - First Floor	F
GMR09001-24.3.13	Proposed Floor Plan - Second Floor	G
GMR09001-24.3-14 - 15	Proposed Sections	D
GMR09001-24.3-16	Proposed Lighting & Electrical - Ground Floor	С
GMR09001-24.3-17	Proposed Lighting & Electrical - First Floor	С
GMR09001-24.3-18	Proposed Lighting & Electrical - Second FLoor	С
GMR09001-24.3-19	Proposed Structural Plan	А
GMR09001-24.3-20	Proposed Sanitary Plan	А
GMR09001-24.3-21	Proposed Water & Ventilation Plan	А
GMR09001-24.3-22 - 24	Proposed Strip Plans	E
GMR09001-24.3-25	Proposed Details	D
GMR09001-24.3-26	General Notes	С





WARNING
BEWARE OF UNDERGROUND SERVICES
The locations of underground services are approximate only and their exact position should be proven on site. No guarantee is given that all existing services are shown.

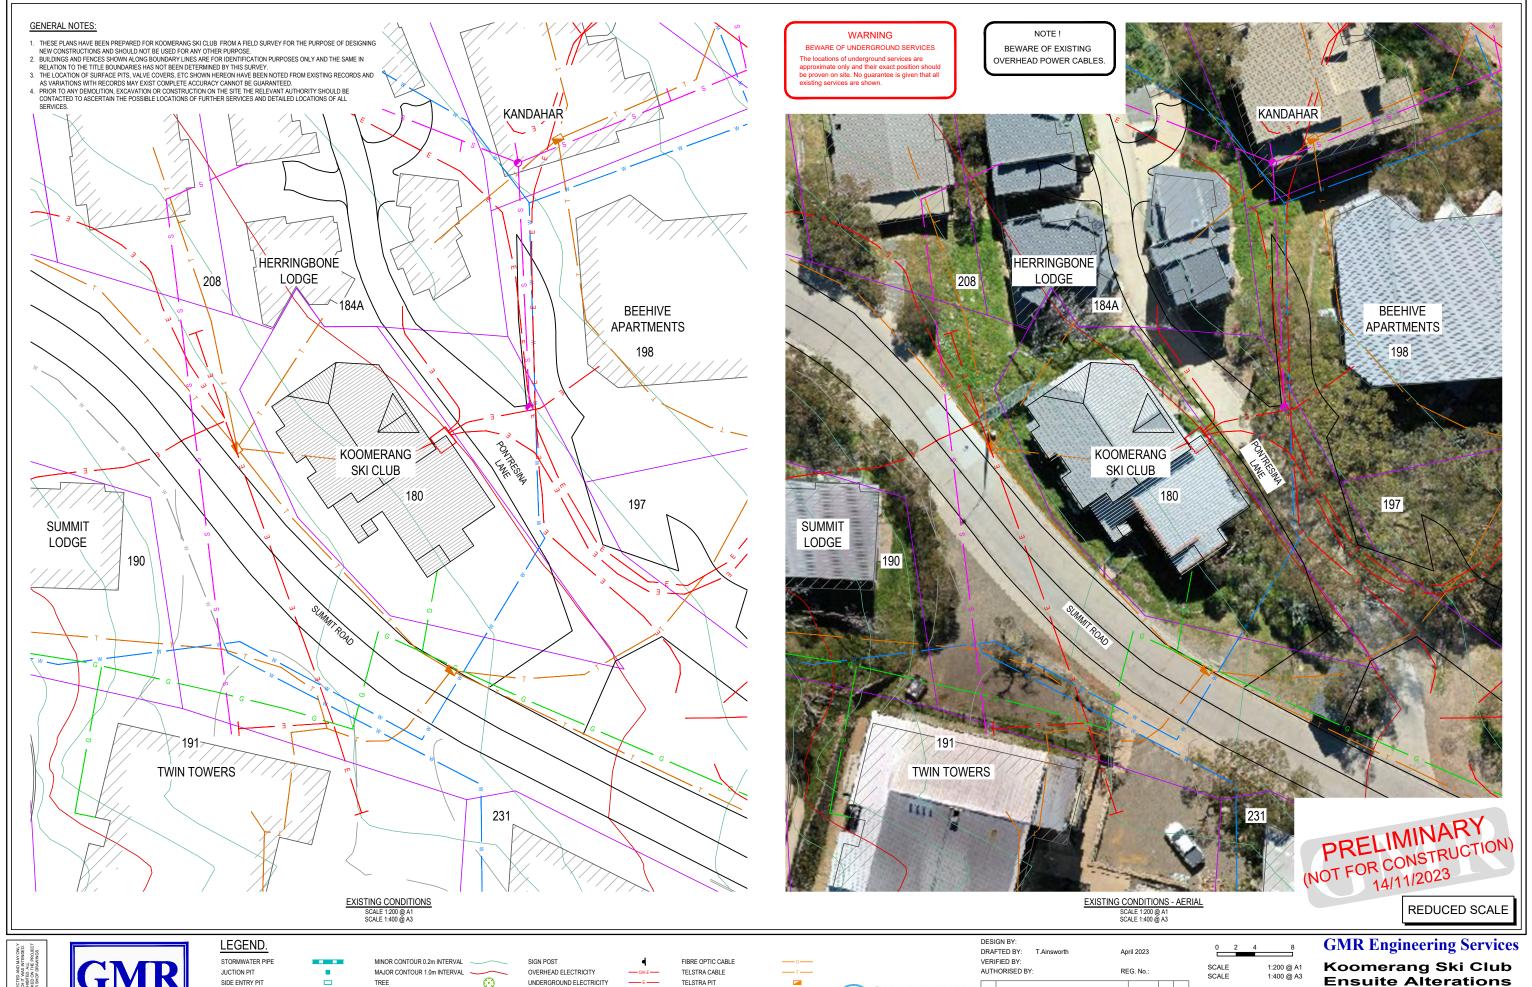





(03) 5822 0333

SIDE ENTRY PIT GRATED TOP ENTRY PIT KERB AND CHANNEL CENTERLINE OF BITUMEN EDGE OF SEAL INVERT OF TABLE DRAIN PROPERTY BOUNDARY

EASEMENT

VEGETATION GROUP DEAD TREE PERMANENT SURVEY MARK SURVEY STATION MARK FENCELINE

GATE

EDGE OF SHOULDER

LIGHT POLE STAY POST SLUICE VALVE FIRE PLUG


WATER SERVICE

WATER TAP

TELSTRA PIT TELSTRA PILLAR SEWER MAIN SEWER RISING MAIN SEWER MANHOLE






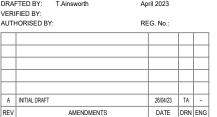




Site No. 180, Summit Road, Mt Buller

Existing Conditions Drawing No. GMR09001-24.3.02 Revision. A GMR09001-24.3.02 Existing Conditions.dwg

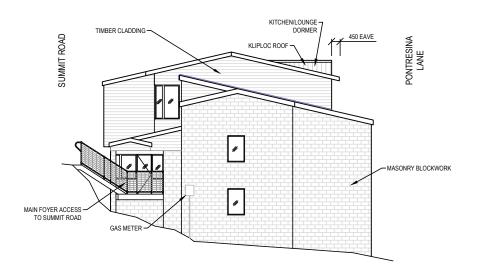




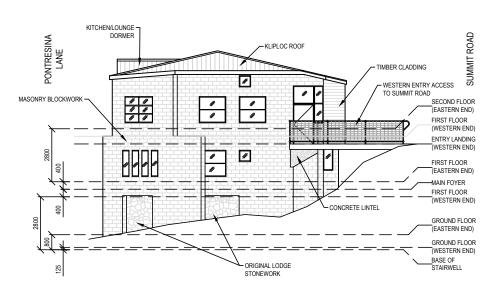


EXISTING WESTERN ELEVATION

SCALE 1:100 @ A1

SCALE 1:200 @ A3

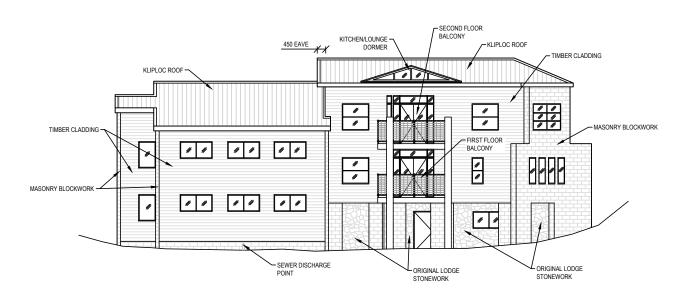

EXISTING NORTHERN ELEVATION
SCALE 1:100 @ A1
SCALE 1:200 @ A3

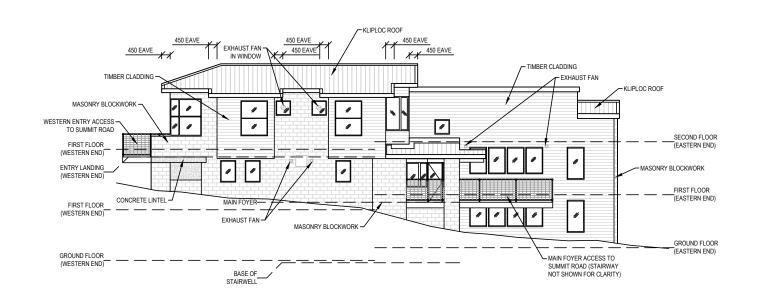


EXISTING SOUTHERN ELEVATION
SCALE 1:100 @ A1
SCALE 1:200 @ A3



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GMR Engineering Service
Koomerang Ski Club
Ensuite Alterations

Site No. 180, Summit Road, Mt Buller

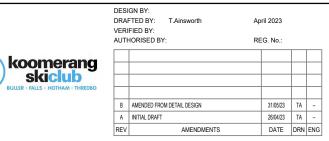
Existing Elevations
Drawing No. GMR09001-24.3.03
Revision. B Sheet No.
GMR09001-24.3.03 Existing Arrangement.dwg

0 1 2

1:100 @ A1

1:200 @ A3

SCALE SCALE

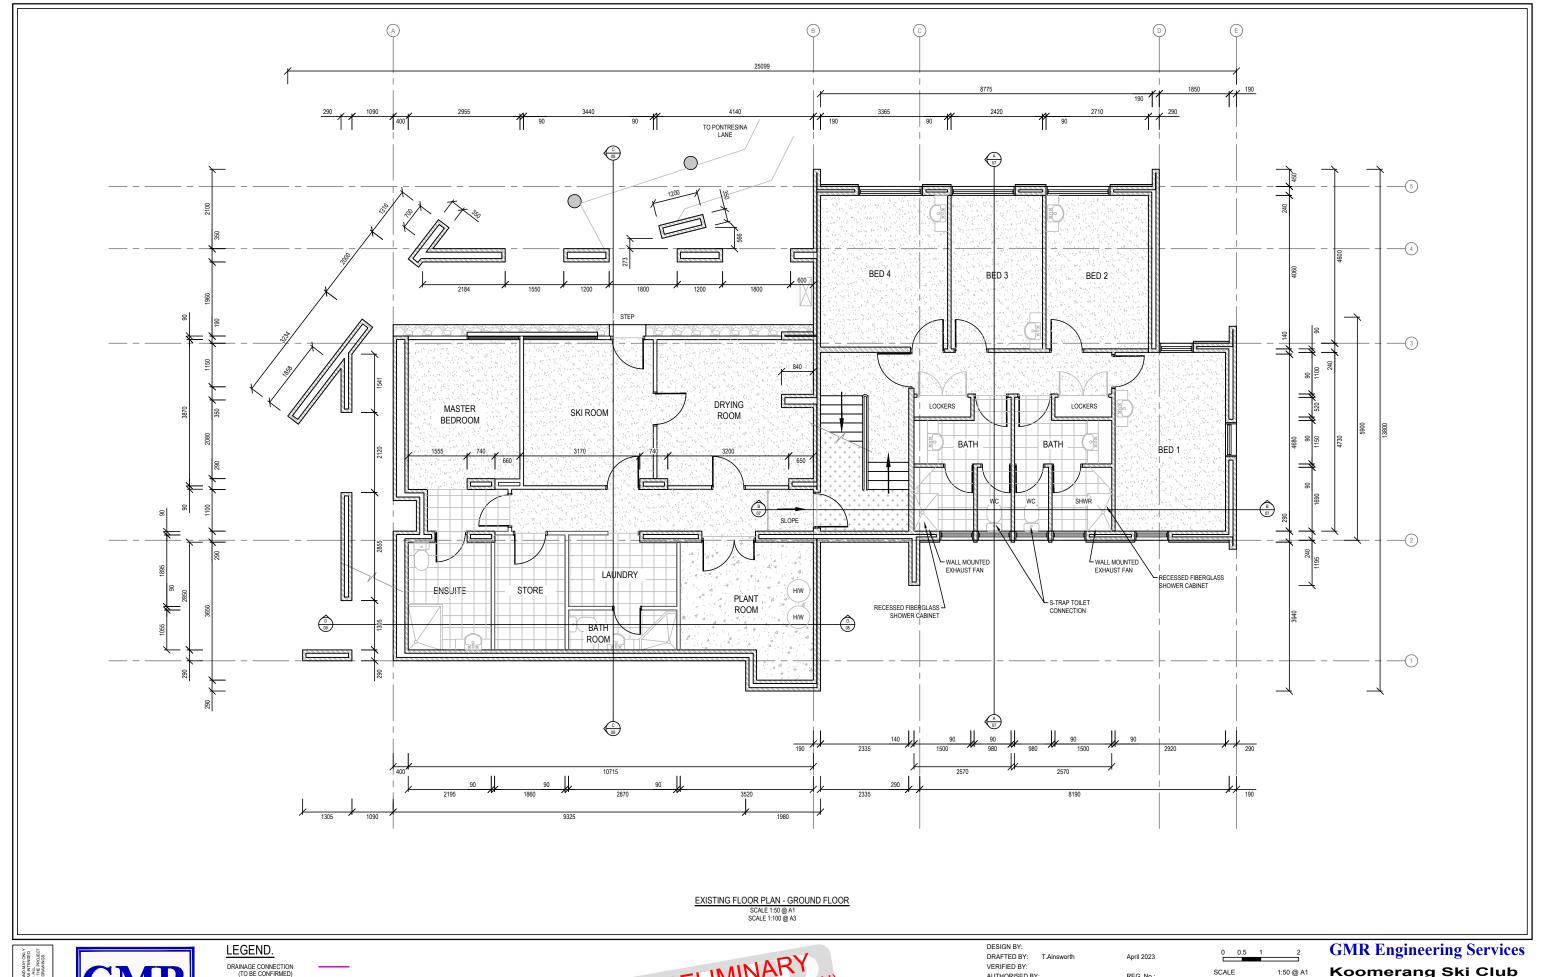






FLOORING - RAW CONCRETE FLOORING - TILE FLOORING - CARPET FLOORING - TIMBER






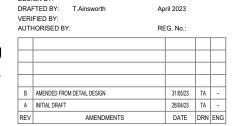

Koomerang Ski Club

Ensuite Alterations Site No. 180, Summit Road, Mt Buller

Existing Floor Plan - Ground Floor Drawing No. GMR09001-24.03.04 Revision. B GMR09001-24.3.03 Existing Arrangement.dwg

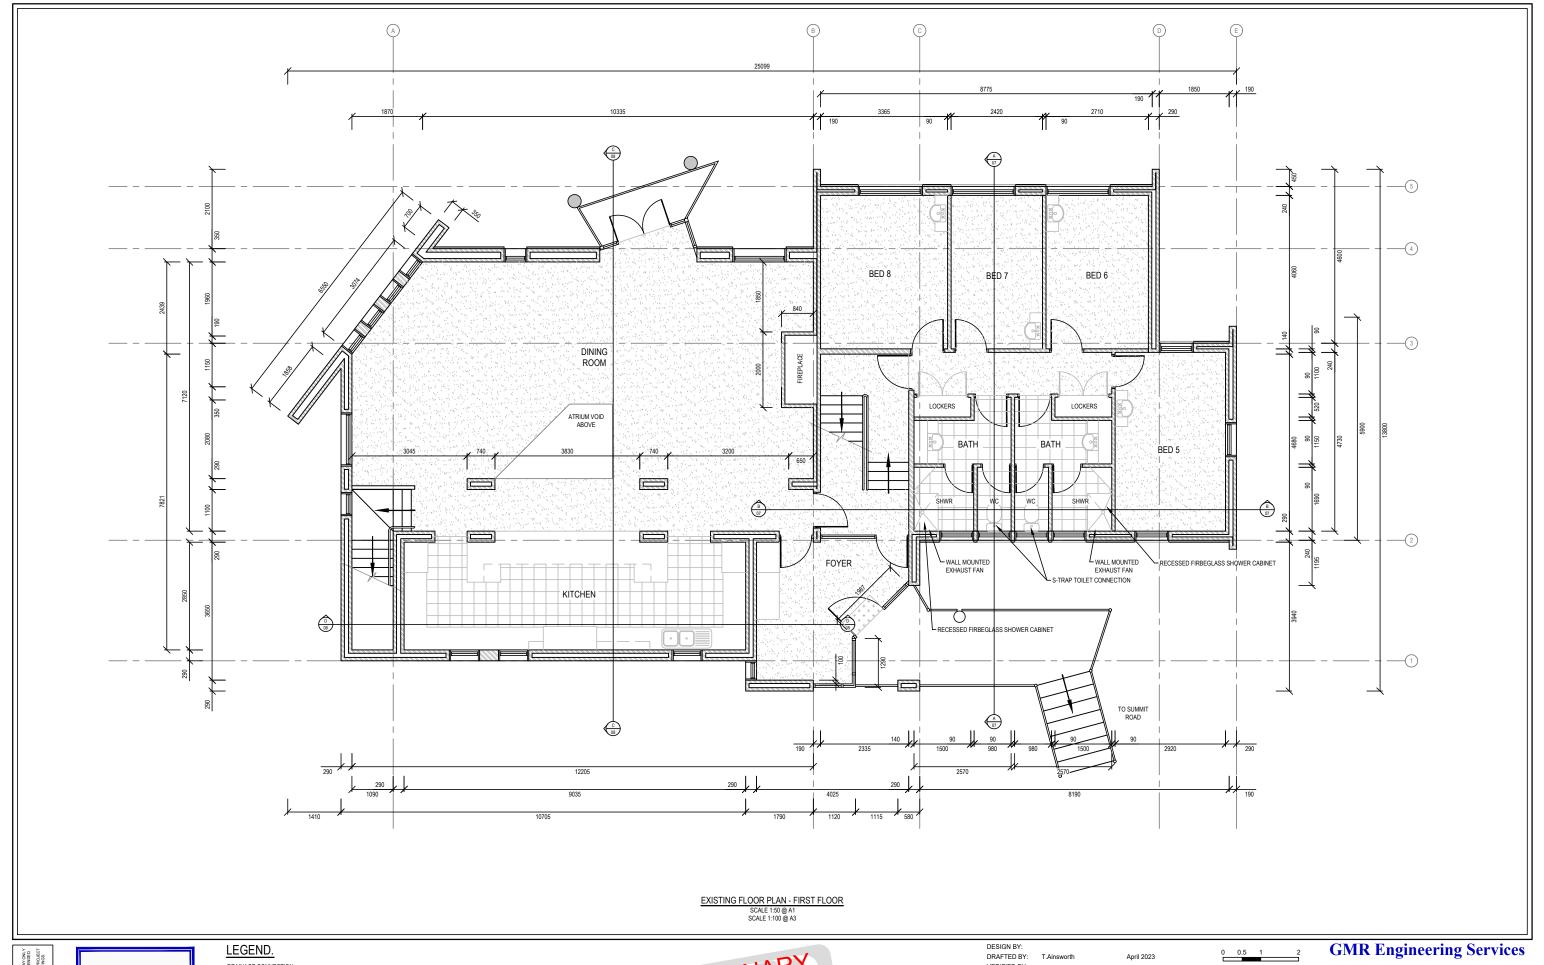






(03) 5822 0333 (03) 5822 0033

DRAINAGE CONNECTION (TO BE CONFIRMED) FLOORING - RAW CONCRETE FLOORING - TILE FLOORING - CARPET FLOORING - TIMBER



REDUCED SCALE




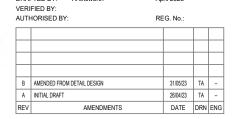




Koomerang Ski Club **Ensuite Alterations** Site No. 180, Summit Road, Mt Buller

Existing Floor Plan - First Floor Drawing No. GMR09001-24.03.05 Revision. B GMR09001-24.3.03 Existing Arrangement.dwg

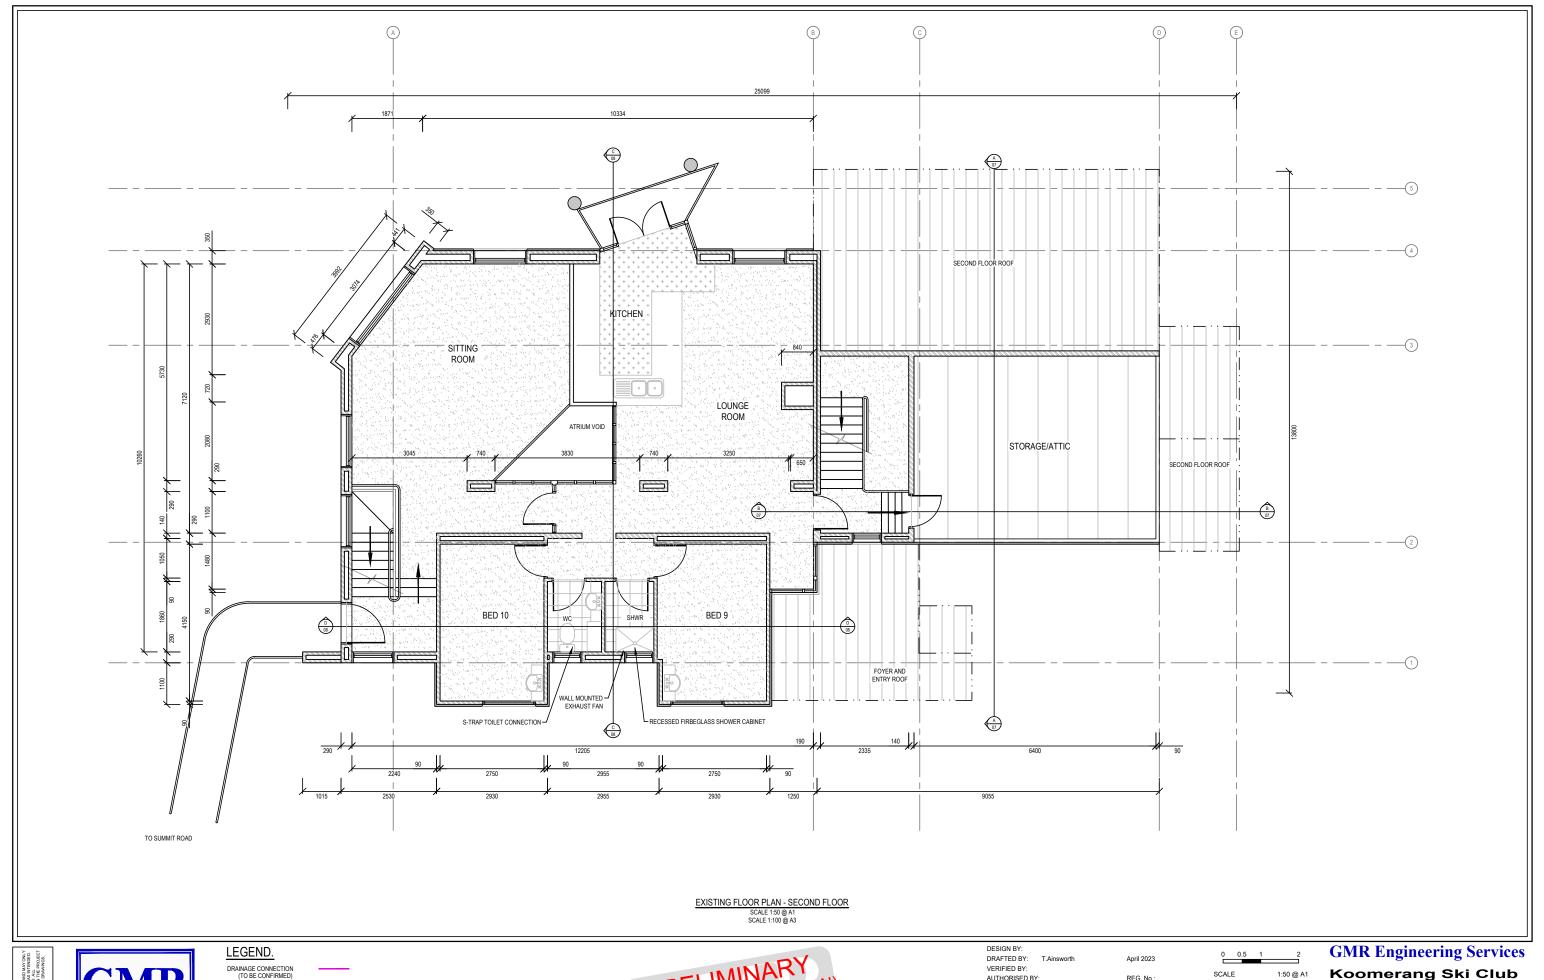





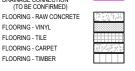


FLOORING - TILE FLOORING - CARPET FLOORING - TIMBER



REDUCED SCALE






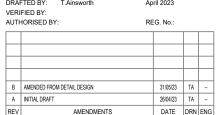




Koomerang Ski Club Ensuite Alterations Site No. 180, Summit Road, Mt Buller

Existing Floor Plan - Second Floor Drawing No. GMR09001-24.03.06 Revision. B GMR09001-24.3.03 Existing Arrangement.dwg

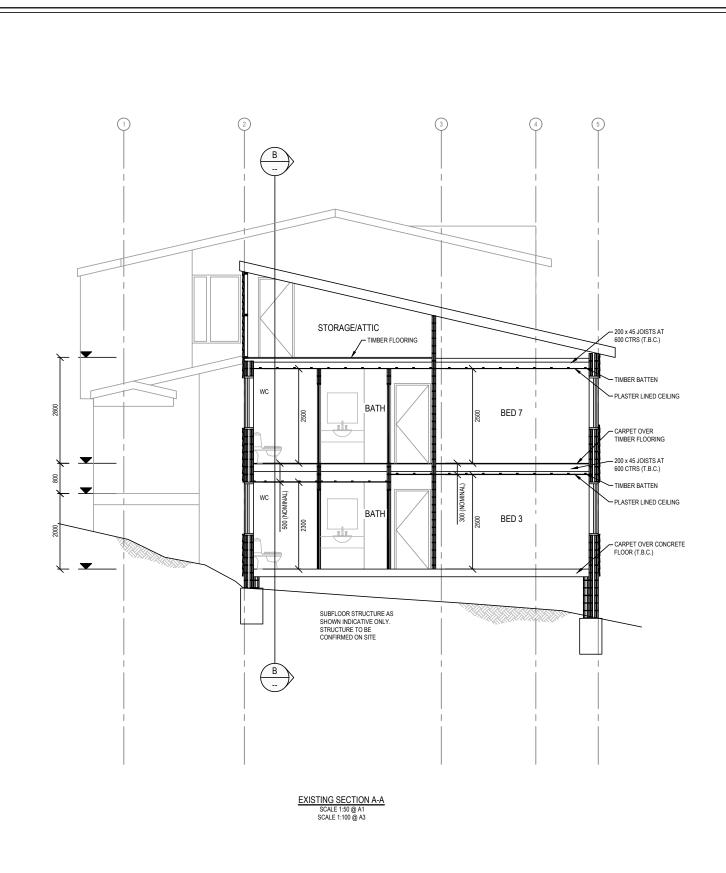

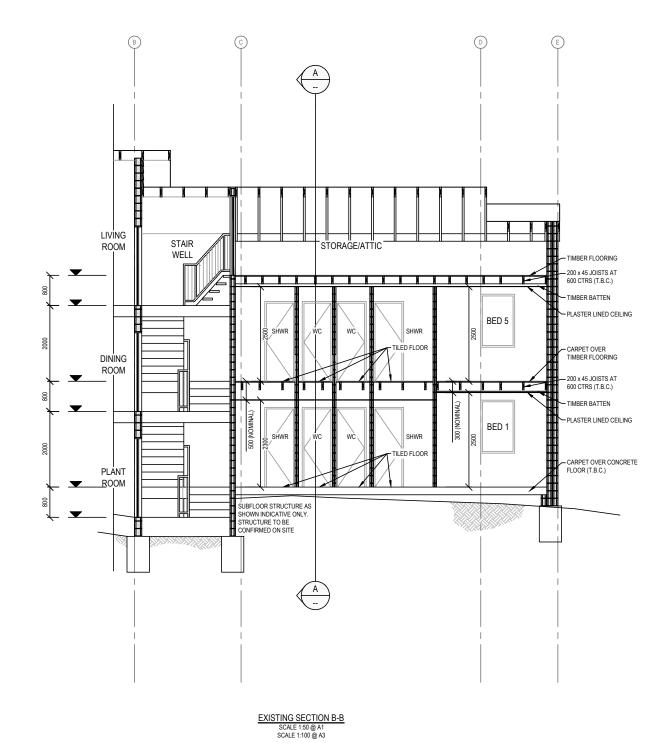

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BE USED FOR THE PRINCES FOR WHICH IT WAS INTENED.

MAINTHON SERVICES AND SECUE SES TRICE.

MICHINES NOS BE CHECKED ON THE PROJECT.



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REDUCED SCALE



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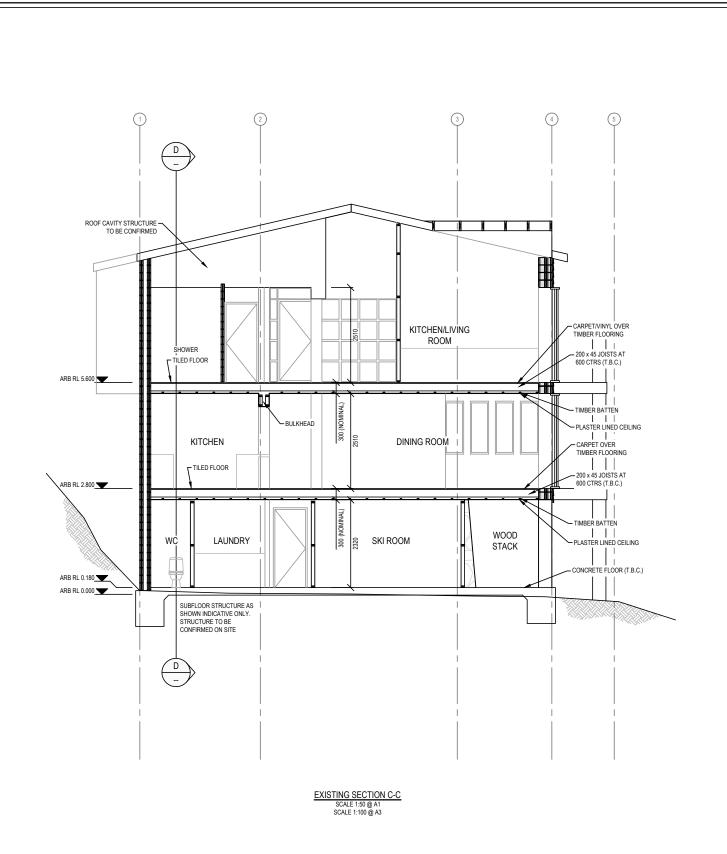
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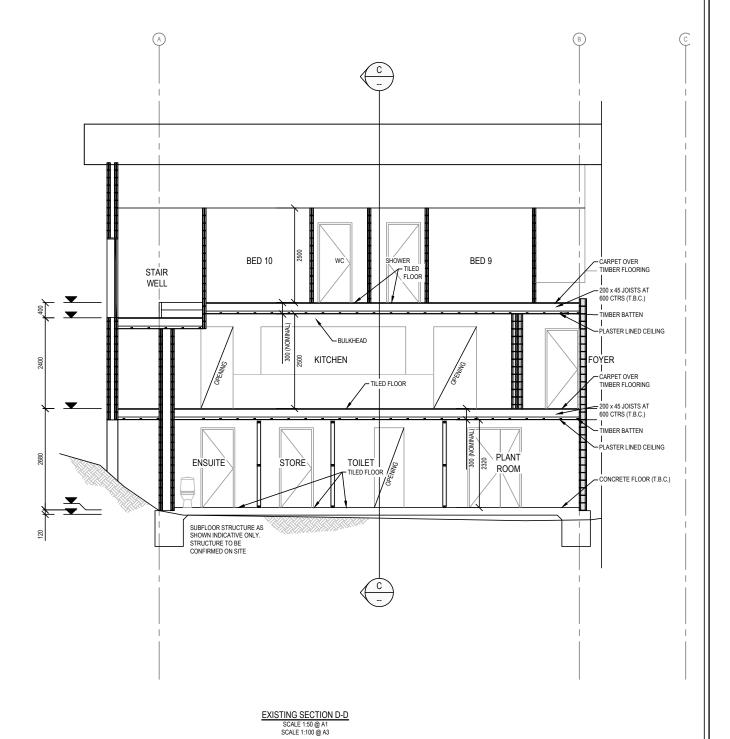
GMR Engineering Services

Koomerang Ski Club Ensuite Alterations

Site No. 180, Summit Road, Mt Buller

Existing Cross Sections
Drawing No. GMR09001-24.3.07
Revision. B Sheet No.
GMR09001-24.3.03 Existing Arrangement.dwg





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REDUCED SCALE




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	UTHORISED BY: REG. No.:				SCAL SCAL
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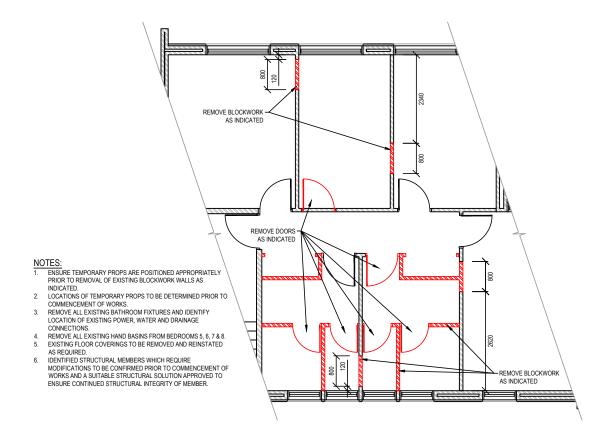
GMR Engineering Services

Koomerang Ski Club Ensuite Alterations


Site No. 180, Summit Road, Mt Buller

Existing Cross Sections
Drawing No. GMR09001-24.3.08
Revision. B Sheet No. 08
GMR09001-24.3.03 Existing Arrangement.dwg



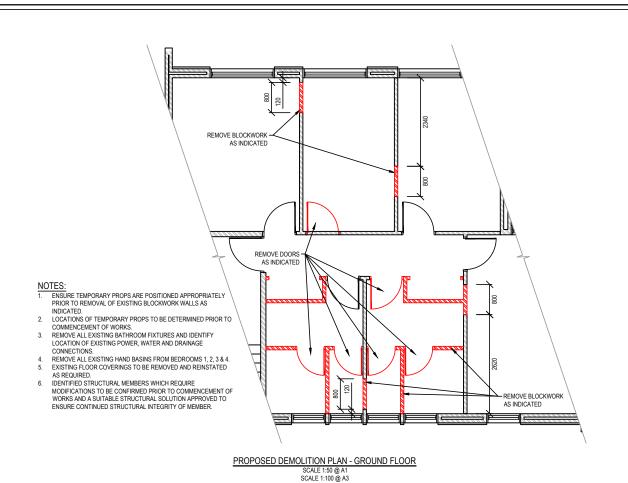


PROPOSED DEMOLITION PLAN - FIRST FLOOR

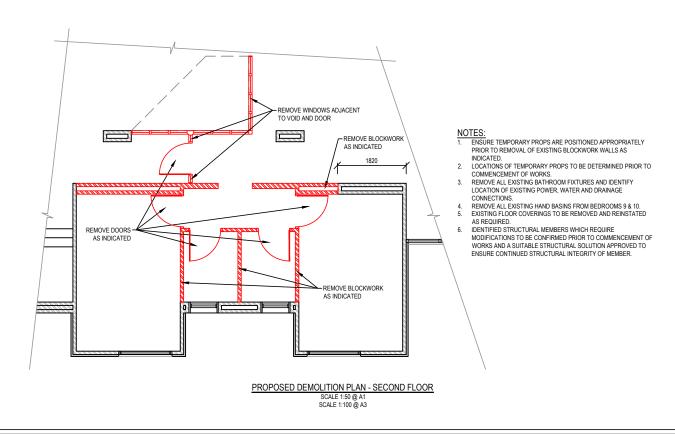

April 2023

April 2023

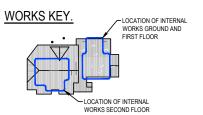



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LEGEND.

DRAINAGE CONNECTION (TO BE CONFIRMED) DEMOLITION - DOORS


DEMOLITION - WINDOWS





REDUCED SCALE




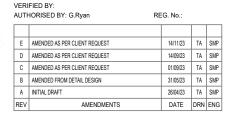

S.Pollard

DESIGN BY:

DRAFTED BY:

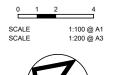




Site No. 180, Summit Road, Mt Buller

Proposed Demolition Plan Drawing No. GMR09001-24.3.09 Revision. E Sheet No. 09


GMR09001-24.3.04 Proposed Demolition.dwg




 NOT ALTERATIONS UNDERTAKEN TO AN EXTERNAL FEATURES, FIXTURES OR FINISHES.

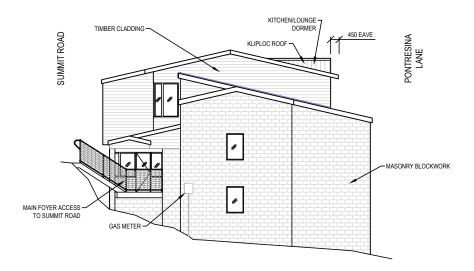


PROPOSED EASTERN ELEVATION
SCALE 1:100 @ A1
SCALE 1:200 @ A3

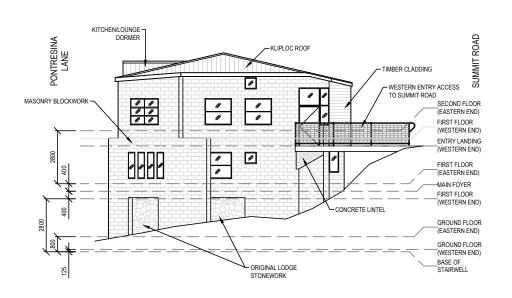

PROPOSED WESTERN ELEVATION
SCALE 1:100 @ A1
SCALE 1:200 @ A3

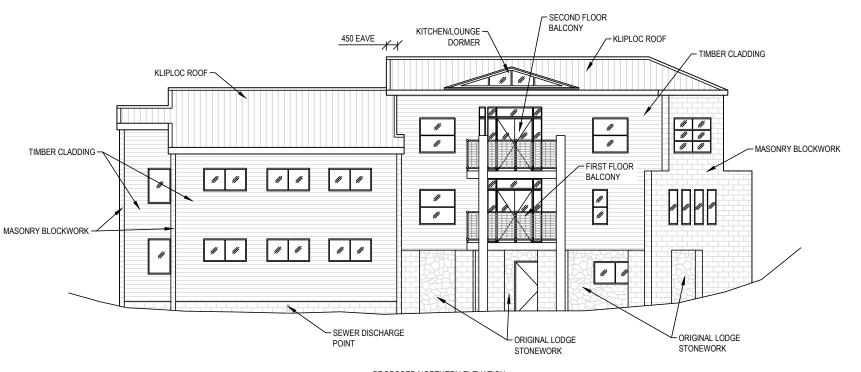

PROPOSED NORTHERN ELEVATION
SCALE 1:100 @ A1
SCALE 1:200 @ A3

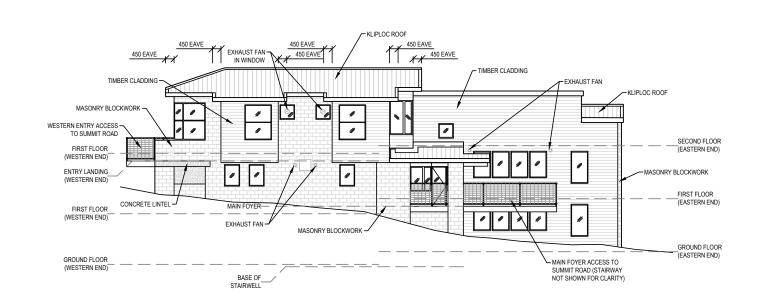

PROPOSED SOUTHERN ELEVATION SCALE 1:100 @ A1 SCALE 1:200 @ A3

DESIGN BY:



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PRELIMINARY
(NOT FOR CONSTRUCTION)
14/11/2023
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/ERI	FIED BY:		ril 2023		
AUTH	HORISED BY: G.Ryan	RE	G. No.:		
В	AMENDED FROM DETAIL DESIGN		31/05/23	TA	SMP
Α	INITIAL DRAFT		26/04/23	TA	SMP
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April 2023

GMR Engineering Services Koomerang Ski Club

Ensuite Alterations


Site No. 180, Summit Road, Mt Buller

Proposed Elevations

Drawing No. GMR09001-24.3.10

Povision P. Sheet No.

1:100 @ A1 1:200 @ A3

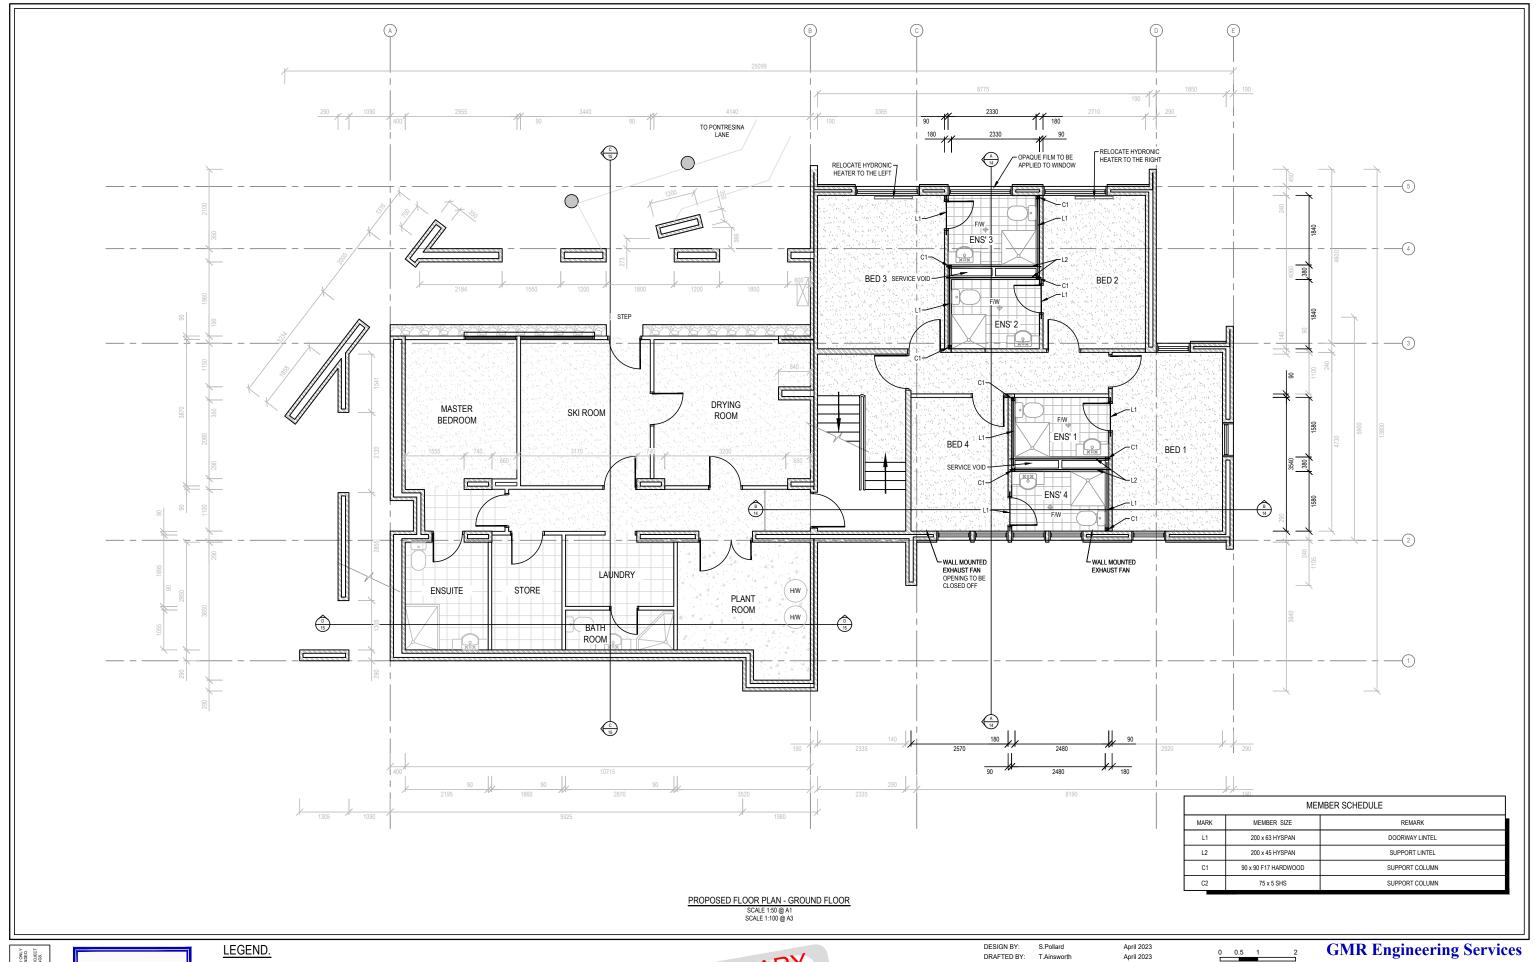





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DRAINAGE CONNECTION (TO BE CONFIRMED) FLOORING - RAW CONCRETE FLOORING - TILE FLOORING - CARPET FLOORING - TIMBER



REDUCED SCALE



REV	AMENDMENTS	DATE	DRN	FNG
A	INITIAL DRAFT	26/04/23	TA	SMP
В	AMENDED FROM DETAIL DESIGN	31/05/23	TA	SMP
С	AMENDED AS PER CLIENT REQUEST	13/07/23	TA	SMP
D	AMENDED AS PER CLIENT REQUEST	01/09/23	TA	SMP
Е	AMENDED AS PER CLIENT REQUEST	14/09/23	TA	SMP
F	AMENDED AS PER CLIENT REQUEST	14/11/23	TA	SMP

REG. No.:

VERIFIED BY:


AUTHORISED BY: G.Ryan



Koomerang Ski Club Ensuite Alterations

Site 180, Summit Road, Mt Buller



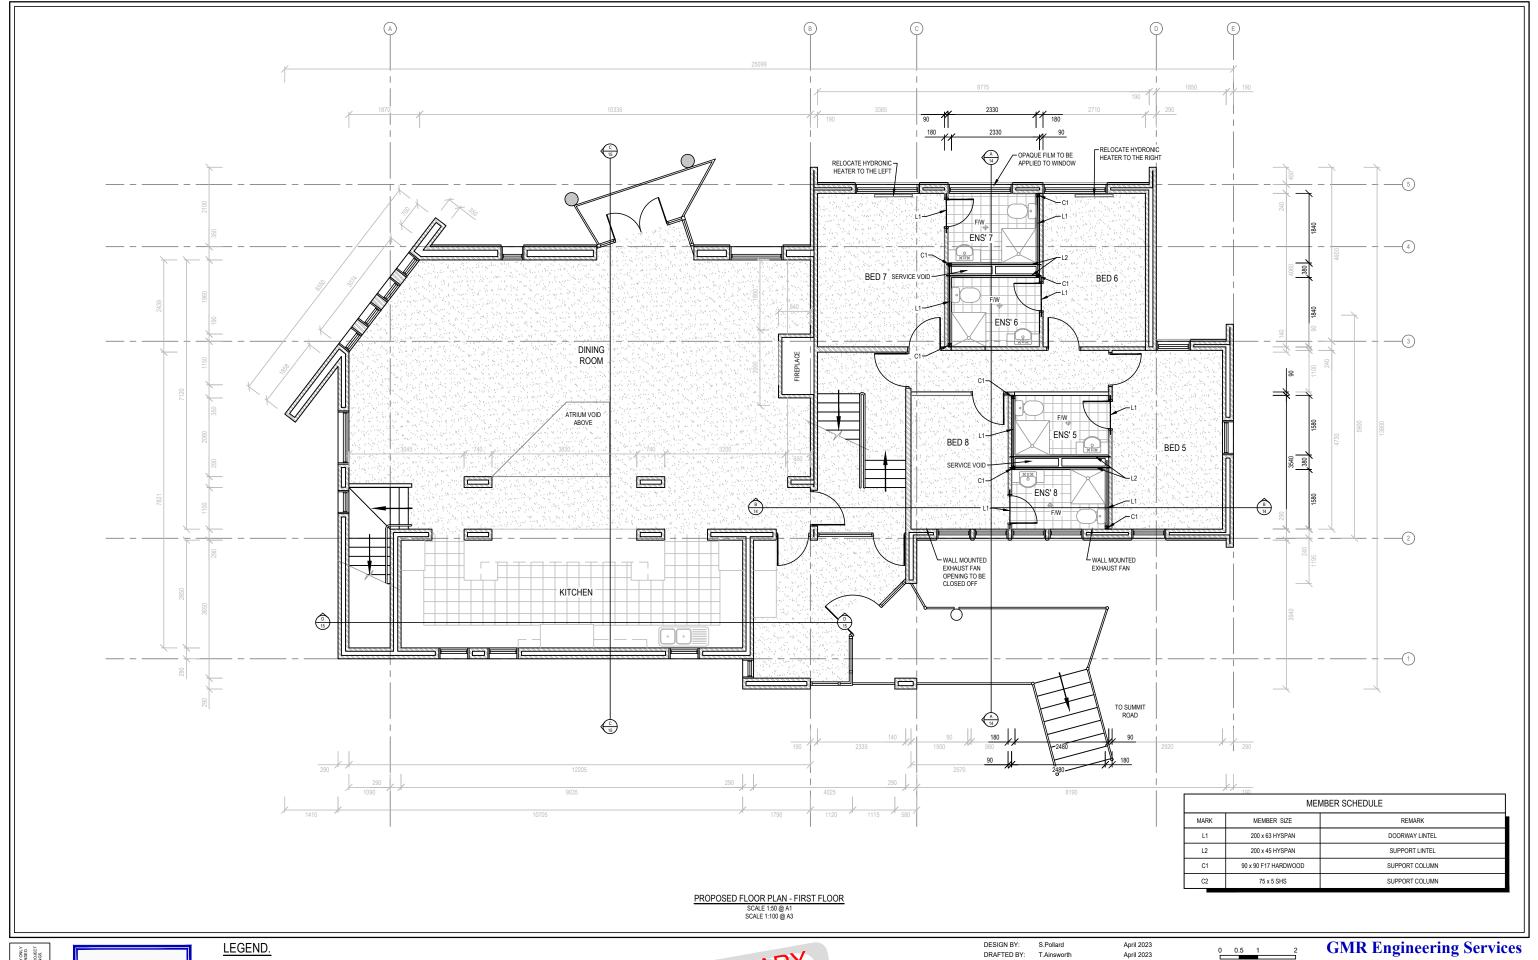





(03) 5822 0333

DRAINAGE CONNECTION (TO BE CONFIRMED) FLOORING - RAW CONCRETE FLOORING - TILE FLOORING - CARPET FLOORING - TIMBER





REDUCED SCALE



REV	AMENDMENTS	DATE	DRN	ENG
Α	INITIAL DRAFT	26/04/23	TA	SMP
В	AMENDED FROM DETAIL DESIGN	31/05/23	TA	SMP
С	AMENDED AS PER CLIENT REQUEST	13/07/23	TA	SMP
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AUTH	HORISED BY: G.Ryan RE	EG. No.:		

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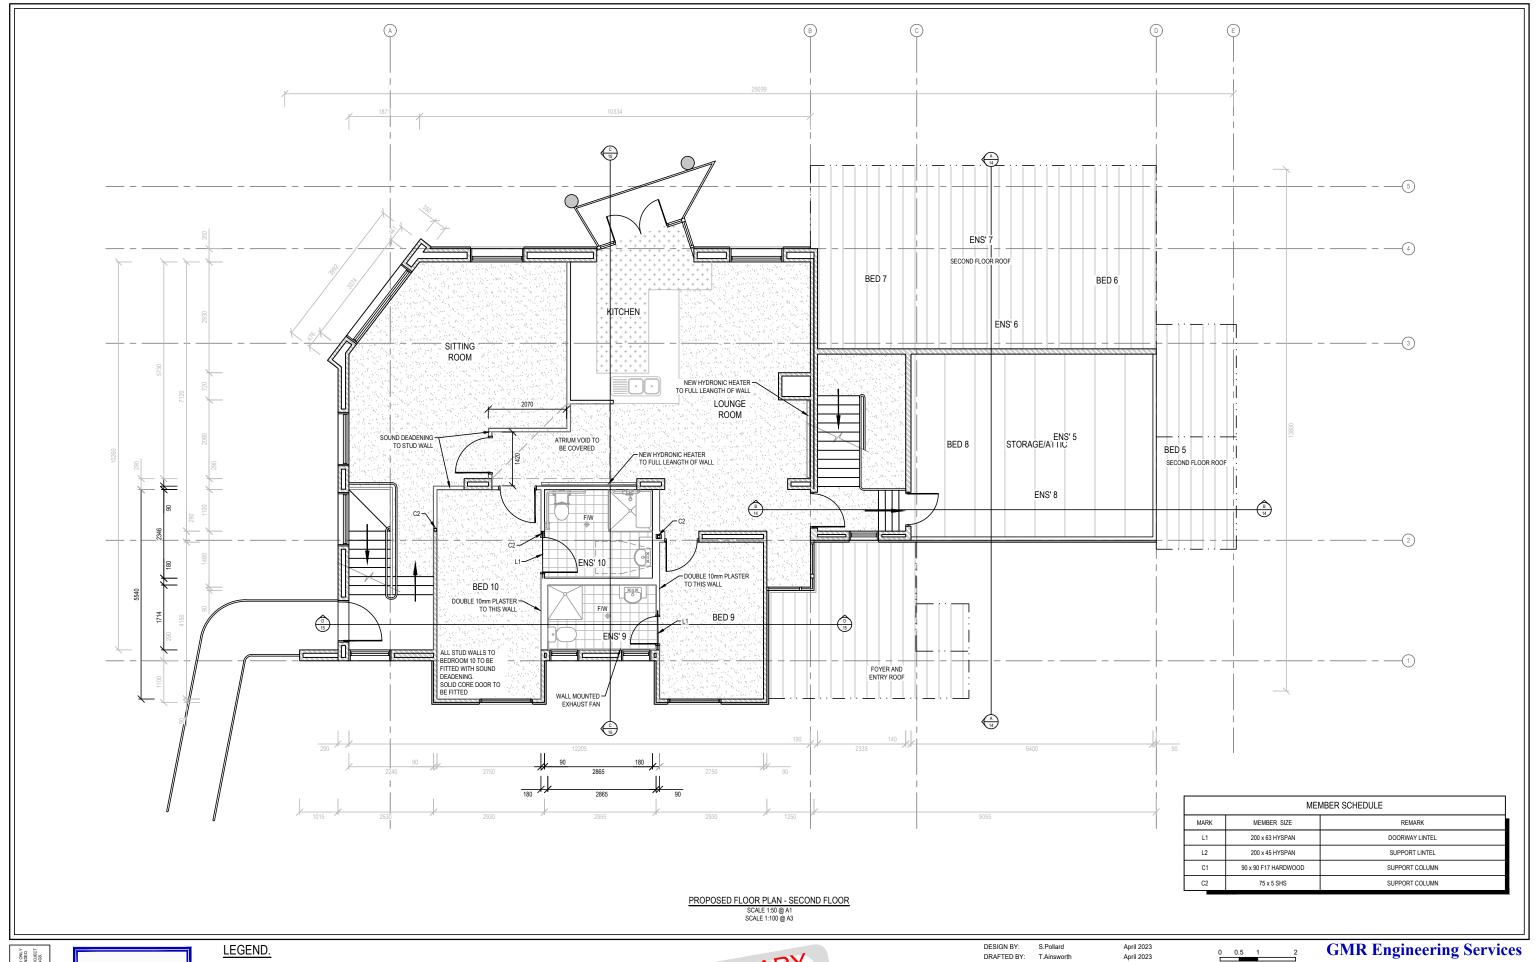




Koomerang Ski Club Ensuite Alterations

Site 180, Summit Road, Mt Buller

Proposed Floor Plan - First Floor Drawing No. GMR09001-24.3.12 Revision. F







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DRAINAGE CONNECTION (TO BE CONFIRMED) FLOORING - RAW CONCRETE FLOORING - TILE FLOORING - CARPET FLOORING - TIMBER





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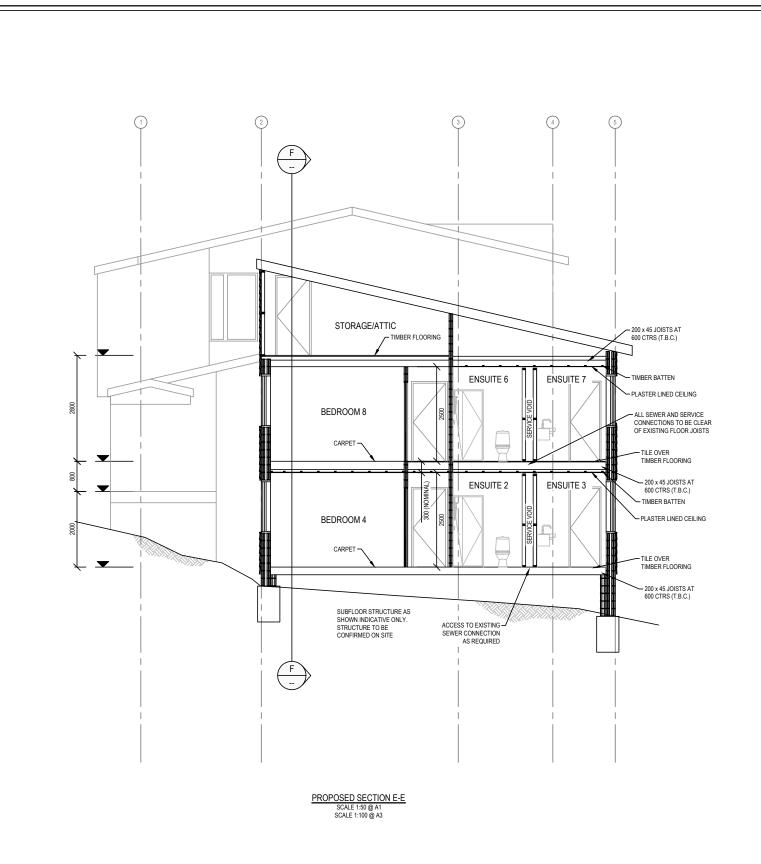
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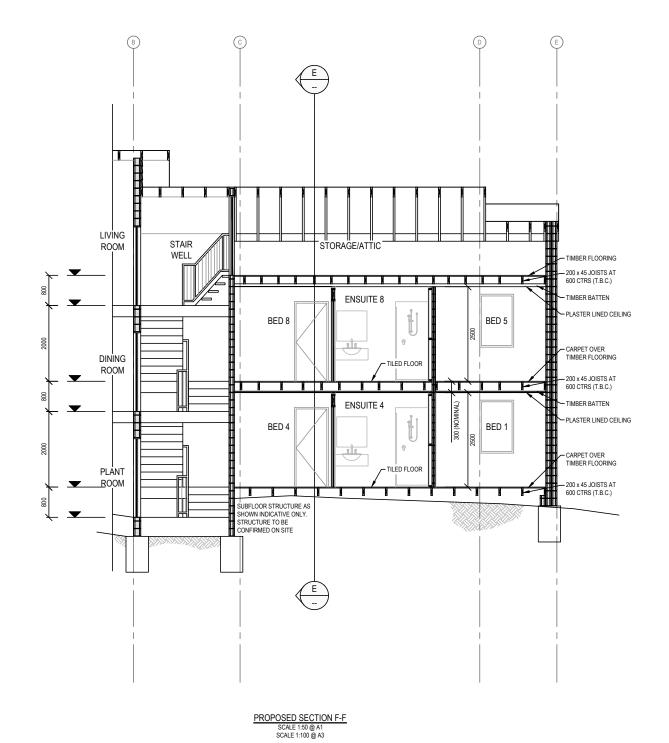


Koomerang Ski Club Ensuite Alterations

Site 180, Summit Road, Mt Buller







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REDUCED SCALE



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April 2023

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S.Pollard


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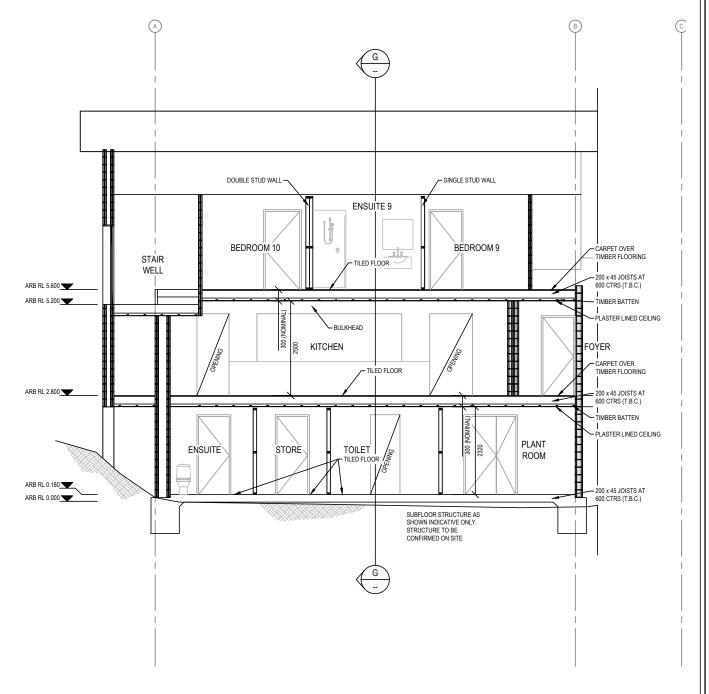
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Koomerang Ski Club Ensuite Alterations

Site No. 180, Summit Road, Mt Buller

Proposed Cross Sections
Drawing No. GMR09001-24.3.14
Revision. D Sheet No. 14
GMR09001-24.3.05 Proposed Arrangement.dwg



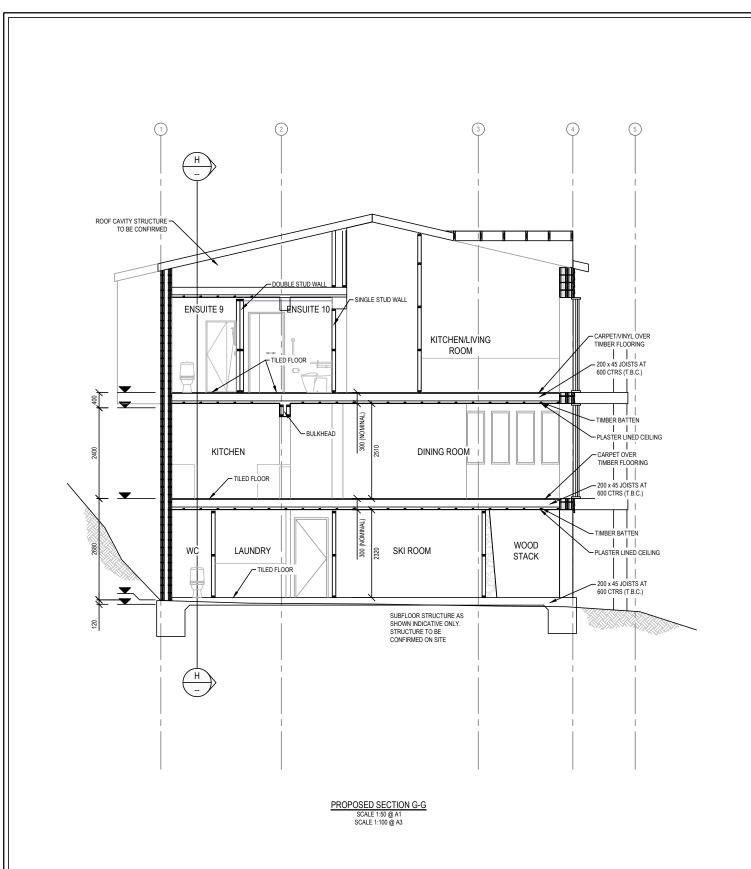

PROPOSED SECTION H-H

SCALE 1:50 @ A1

SCALE 1:100 @ A3

April 2023

April 2023

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1:50 @ A1 1:100 @ A3

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(03) 5822 0033

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D	AMENDED AS PER CLIENT REQUEST		14/11/23	TA	SMP	
С	AMENDED AS PER CLIENT REQUEST		01/09/23	TA	SMP	
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REV	AMENDMENTS		DATE	DRN	ENG	

S.Pollard

DESIGN BY:


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Koomerang Ski Club Ensuite Alterations

Site No. 180, Summit Road, Mt Buller

Proposed Cross Sections
Drawing No. GMR09001-24.3.15
Revision. D Sheet No. 15
GMR09001-24.3.05 Proposed Arrangement.dwg





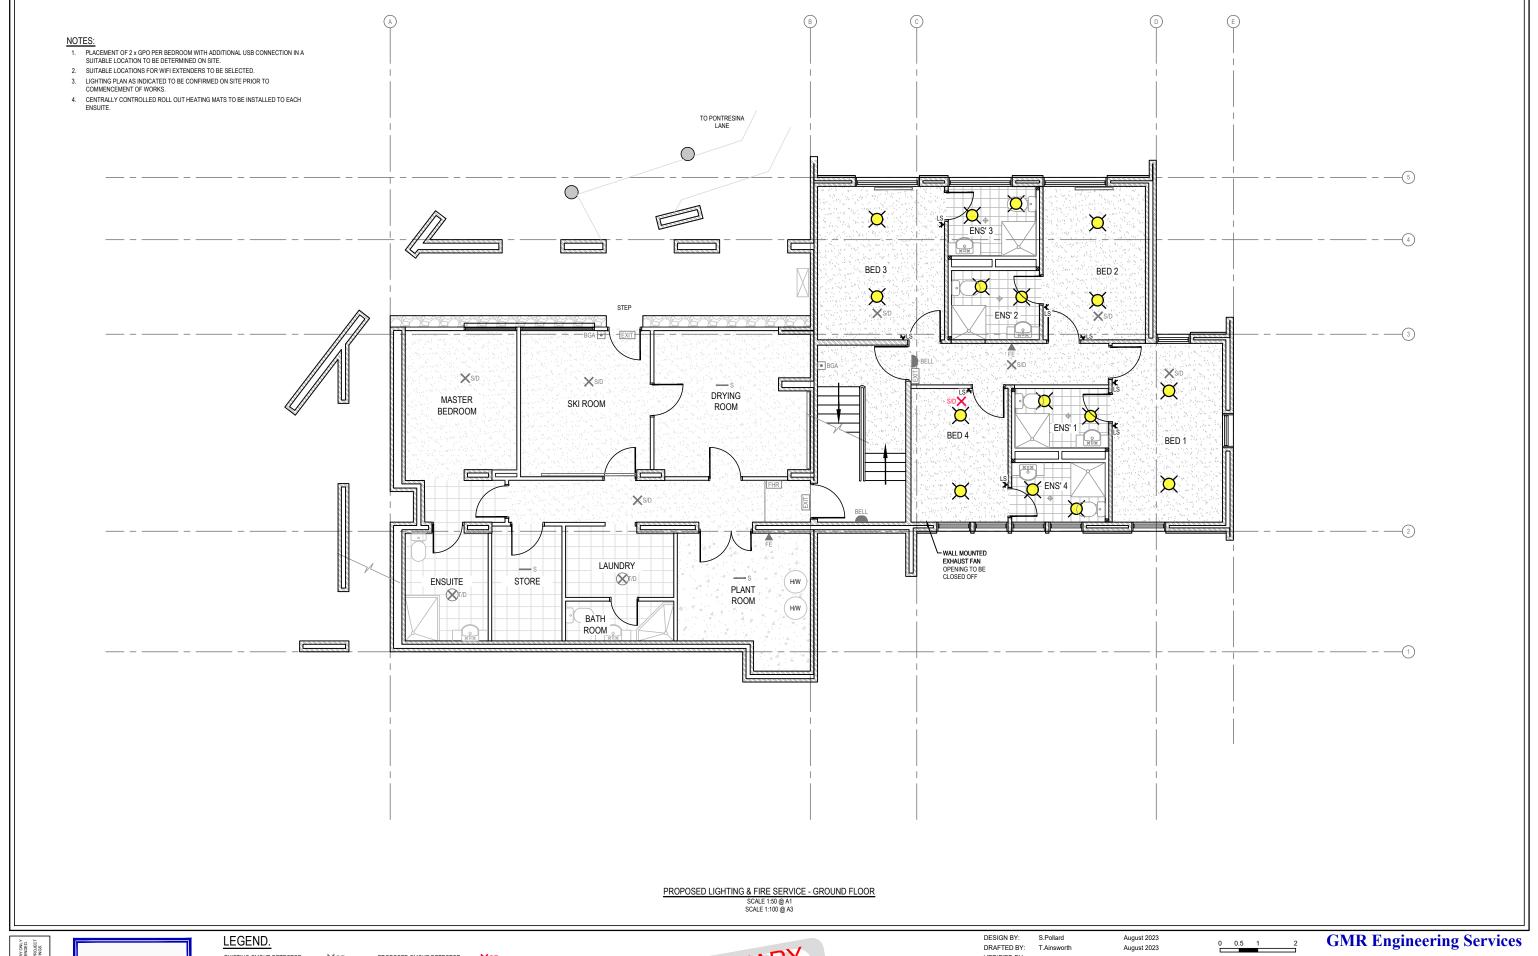

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EXISTING FIRE HOSE REAL EXISTING ALARM BELL EXISTING FIRE EXTINGUISHER EXISTING SPRINKLER EXISTING EXIT SIGN

EXISTING SMOKE DETECTOR EXISTING THERMAL DETECTOR EXISTING BREAK GLASS ALARM **D**BELL **▲**FE PROPOSED SMOKE DETECTOR PROPOSED ALARM BELL PROPOSED EXIT SIGN





REDUCED SCALE



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REV	AMENDMENTS	DATE	DRN	ENG

Koomerang Ski Club Ensuite Alterations

Site No. 180, Summit Road, Mt Buller

Proposed Lighting & Electrical - Ground Floor Drawing No. GMR09001-24.3.16 Revision. B

GMR09001-24.3.06 Proposed Services.dwg







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EXISTING SMOKE DETECTOR EXISTING THERMAL DETECTOR EXISTING FIRE HOSE REAL EXISTING BREAK GLASS ALARM EXISTING ALARM BELL EXISTING FIRE EXTINGUISHER EXISTING SPRINKLER

EXISTING EXIT SIGN

DBELL **▲**FE

PROPOSED SMOKE DETECTOR PROPOSED ALARM BELL PROPOSED EXIT SIGN













02/08/23 TA SMP




Koomerang Ski Club Ensuite Alterations

Site No. 180, Summit Road, Mt Buller

Proposed Lighting & Electrical - First Floor Drawing No. GMR09001-24.3.17 Revision. B

GMR09001-24.3.06 Proposed Services.dwg

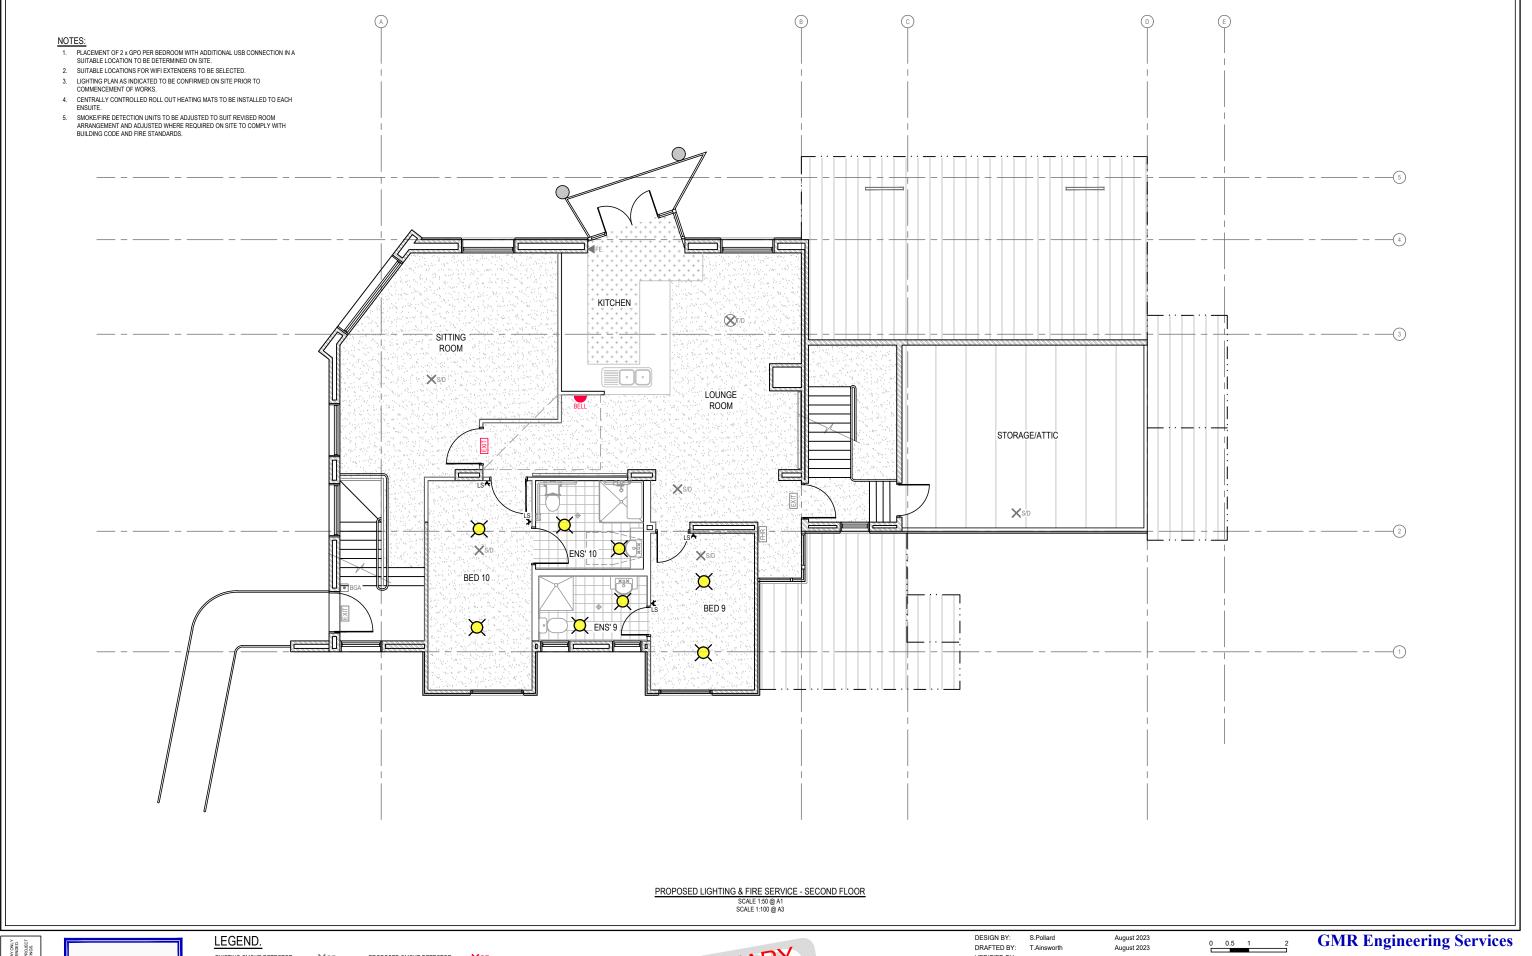





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EXISTING SMOKE DETECTOR
EXISTING THERMAL DETECTOR
EXISTING FIRE HOSE REAL
EXISTING BREAK GLASS ALARM
EXISTING ALARM BELL
EXISTING FIRE EXTINGUISHER
EXISTING FIRE PANEL
EXISTING FIRE PANEL
EXISTING EXIT SIGN

PROPOSED SMOKE DETECTOR
PROPOSED ALARM BELL
PROPOSED EXIT SIGN
BGA
PROPOSED DOWN LIGHT
FE

X S/D BELL EXIT X



REDUCED SCALE



SKICIUD
BULLER - FALLS - HOTHAM - THREDBO

C AMNEE
B AMENE
A INITIAL

DESI	GN BY:	S.Pollard	Au	August 2023 August 2023		
DRA	FTED BY:	T.Ainsworth	Au			
	FIED BY:					
AUTH	HORISED B	Y: G.Ryan	RE	G. No.:		
С	AMNEDED AS	PER CLIENT REQUEST		14/11/23	TA	SMP
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Α	INITIAL DRAFT			02/08/23	TA	SMP
REV		AMENDMENTS		DATE	DRN	ENG



Koomerang Ski Club Ensuite Alterations

Site No. 180, Summit Road, Mt Buller

Proposed Lighting & Electrical - Second Floor Drawing No. GMR09001-24.3.18 Revision. C Sheet No. 18

Revision. C Sheet No.
GMR09001-24.3.06 Proposed Services.dwg





- ALL NEW FLOORS IN BEDROOMS AND BATHROOMS TO BE 19mm THK K-FLOOR TOUNG AND GROOVE.
- 2. ALL DOORS ARE TO BE SELF CLOSING AND SHALL BE --/60/30 FIRE RATED.
- 3. ALL NEW CEILING LINING SHALL BEZ LAYERS WITH ONE BEING 10mm THK K-CLAD
 (TE10) INTERIOR AND ONE BEING 10mm THK K-CLAD (SE10) EXTERIOR WHERE
 REQUIRED, JOINTS OF SHEETING TO BE OFFSET BY 50mm/75mm. CEILING GLASS
 WOOL BATTS R5.0 TO BE PLACED ABOVE CEILING LINING FOR ACOUSTIC REQUIREMENTS.
- REQUIREMENTS.


 4. ALL WALLS DEPICTED 1 2 LAYER 10mm THK K-CLAD (TE10) INTERIOR ON HALLWAY SIDE FOR ACOUSTIC INSULATION, 90mm STUD WALL WITH GLASS WOOL BATTS R2.5 IN BETWEEN STUDS, 1 LAYER 10mm THK K-CLAD (TE10) INTERIOR.

 5. ALL WALLS DEPICTED 1 1 LAYER 10MM THK K-CLAD (TE10) INTERIOR ON HALLWAY SIDE FOR ACOUSTIC INSULATION, 90MM STUD WALL WITH GLASS WOOL BATTS R2.5 IN BETWEEN STUDS, 1 LAYER 10MM THK K-CLAD (TE10) INTERIOR.

 6. ALL WALLS DEPICTED 1 1 LAYER 10MM THK K-CLAD (TE10) INTERIOR ON HALLWAY SIDE FOR ACOUSTIC INSULATION, 90MM STUD WALL
- ALL K-CLAD TO BE INSTALLED AS PER MANUFACTURERS SPECIFICATIONS AND REQUIREMENTS.
- ALL WALL PENETRATIONS TO BE PROTECTED BY FIRE RATED 'FIRE COLLARS' AS PER MANUFACTURERS REQUIREMENTS.
- ALL DOORS TO HAVE A SUITABLE WALL MOUNTED DOOR STOP FITTED TO ENSURE WALLS ARE PROTECTED FROM DAMAGE.
- 10. DOOR HARDWARE TO BE CONFIRMED ONSITE PRIOR TO FITMENT OF DOORS.
- ALL EXISTING BEDROOM STORAGE UNITS TO BE ADJUSTED AND MODIFED WHERE REQUIRED TO SUIT REVISED ROOM ARRANGEMENTS.
 ALL ENSUITES TO BE FITTED WITH ELECTRIC FLOOR HEATING ELEMENTS AS SPECIFIED BY CLIENT.

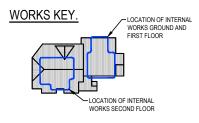

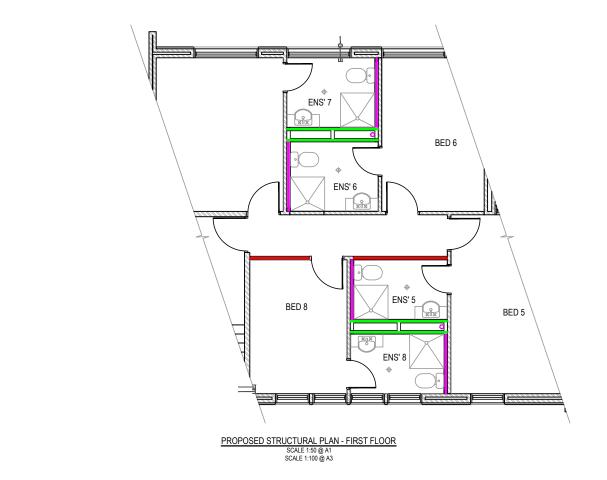

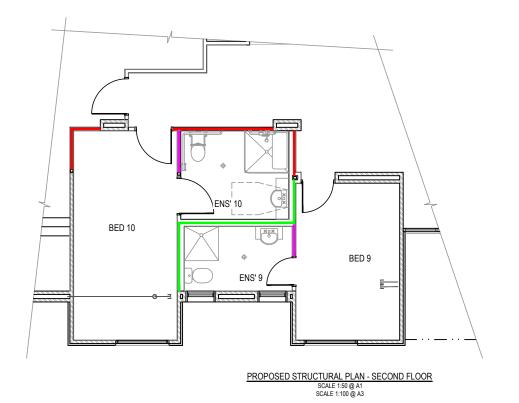



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REDUCED SCALE



		FIED BY: HORISED BY: G.Ryan
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HREDBO		
	A	INITIAL DRAFT
	REV	AMENDMENTS

S.Pollard

DESIGN BY:

DRAFTED BY:

November 2023 SCALE


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GMR Engineering Services Koomerang Ski Club Ensuite Alterations

Site No. 180, Summit Road, Mt Buller

Proposed Structural Plan Drawing No. GMR09001-24.3.19 Revision. A

Sheet No. 19 GMR09001-24.3.06 Proposed Services.dwg




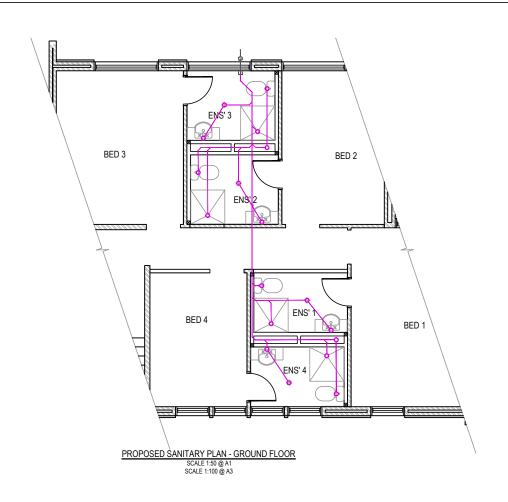


ALL CONNECTIONS TO EXISTING SERVICES TO BE CONFIRMED ON SITE PRIOR TO COMMENCEMENT OF WORKS.

WASTE FIXTURE SCHEDULE				
FIXTURE TRAP SIZE WASTE SIZE COMMENT				
BASIN	Ø40	Ø40	RISER IN WALL	
FLOOR WASTE	Ø100	Ø100	Ø100 FLOOR GRATE	
SHOWER	Ø100	Ø100	Ø100 FLOOR GRATE	
WATER CLOSET	Ø100	Ø100	SETOUT T.B.C.	



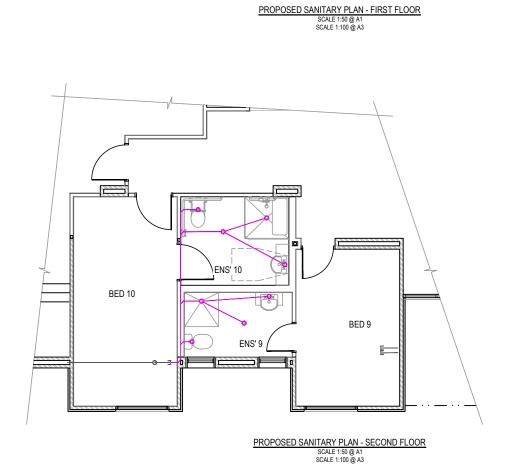

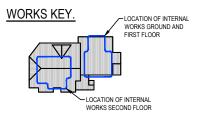



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LEGEND.

SANITARY SERVICE SANITARY CONNECTION POINT



REDUCED SCALE





DESIGN BY:

DRAFTED BY:



November 2023

BED 6

BED 5


ENS' 6

BED 8



Site No. 180, Summit Road, Mt Buller

Proposed Sanitary Plan Drawing No. GMR09001-24.3.20 Revision. A

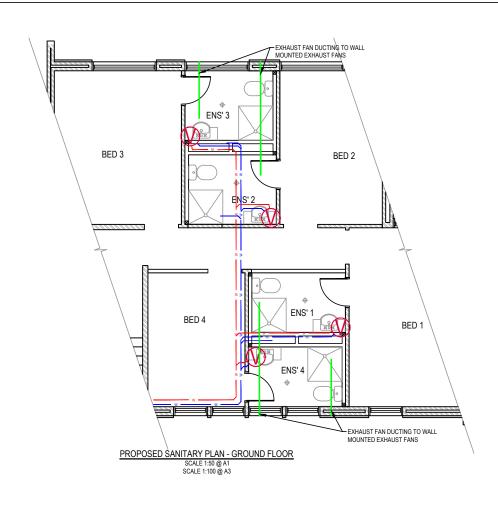





- ALL CONNECTIONS TO EXISTING SERVICES TO BE CONFIRMED ON SITE PRIOR TO COMMENCEMENT OF WORKS.
 CONNECT TO EXISTING HOT & COLD WATER PIPEWORK SUPPLYING THE EXISTING DEMOLISHED BATHROOMS AND EXTEND TO NEW FIXTURES AND TEMPERING VALVES.
- 3. HOT WATER TEMPERING VALVE FIXED WITHIN VANITY CABINET BELOW BENCH AND PRE SET TO 50 °C; TYPICAL.

 4. ALL WATER POINTS TO BE FITTED WITH A WATER STOP.
- 5. VENTILATION DUCTWORK TO BE SEPARATE TO EACH ENSUITE, POSITIONED TO CEILING CAVITY AND ENCASED IN 10mm THK K-CKAD (TE10) INTERIOR.
- ALL ENSUITE EXHAUST FANS TO BE FITTED TO EXTERNAL WALLS AND TO HAVE A MIN.
 100l/s AIR FLOW. 7. EXHAUST FANS TO BE FITTED WITH TIMER. TIME LIMIT TO BE SET TO SUIT REQUIREMENTS OF CLIENT ON SITE.

WATER SERVICES SCHEDULE				
FIXTURE	HOT WATER MINI-STOP	COLD WATER MINI-STOP	COMMENT	
BASIN	Ø15 (W.W)	Ø15	600 A.F.F.L.	
SHOWER	Ø15 FLICK MIXER (W.W)		950 A.F.F.L.	
WATER CLOSET	N/A	Ø15	200 A.F.F.L. (T.B.C. ON SITE)	

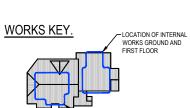



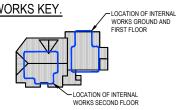



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LEGEND. WATER SERVICE - COLD

WATER SERVICE - HOT TEMPERING VALVE







BED 10



DESIGN BY:

DRAFTED BY:

VERIFIED BY:

0 0.5 1

ENS' 7

BED 8

PROPOSED SANITARY PLAN - FIRST FLOOR

BED 9

EXHAUST FAN DUCTING TO WALL

PROPOSED SANITARY PLAN - SECOND FLOOR SCALE 1:50 @ A1 SCALE 1:100 @ A3

November 2023

BED 6

BED 5

EXHAUST FAN DUCTING TO WALL MOUNTED EXHAUST FANS

ENS' 5



GMR Engineering Services Koomerang Ski Club Ensuite Alterations

Site No. 180, Summit Road, Mt Buller

Proposed Water & Ventilation Plan Drawing No. GMR09001-24.3.21 Revision. A GMR09001-24.3.06 Proposed Services.dwg

PROPOSED ENSUITE FINISHES			
MARK	MEMBER SIZE	REMARK	
FL1	FLOOR TILES	OMNIFORM CHARCOAL TEXTURED	
TW1	150mm HIGH SKIRTING TILES	ENDEARING WHITE SATIN FINISH	
TW2	SHOWER RECESS TILES	ENDEARING WHITE SATIN FINISH	
TW3	SPLASHBACK TILES	ENDEARING WHITE SATIN FINISH	

PROPOSED ENSUITE PLUMBING FIXTURES			
MARK	MEMBER SIZE	REMARK	
BAS	HAND BASIN	REBA GLOSS WHITE ABOVE COUNTER	
TCI	CISTERN	(REFER TO PAN)	
TPA	PAN	CAROMA LUNA CLEANFLUSH TOILET SUITE	
	SHOWER BASE	RECESSED WITH POLY MARBLE FINISH	

PROPOSED ENSUITE FITTINGS			
MARK	MEMBER SIZE	REMARK	
DPP	DOUBLE POWER POINT	(TO BE SELECTED)	
MIR	MIRROR	(TO BE SELECTED)	
SNZ	SHOWER NOZZLE	POSH BRISTOL SINGLE SHOWER RAIL	
STP	SHOWER TAP WARE	GROHE BAUEDGE SHOWER/BATH MIXER	
TAP	BASIN TAP WARE	CAROMA CHROME JADE TOWER BASIN MIXER	
VAN	VANITY CABINET	ALINA FLUTED SCANDI OAK	


	PROPOSED ENSUITE HARDWARE			
MARK	MEMBER SIZE	REMARK		
SSF	SHOWER SHELF	PHEONIX CHROME APLO SHOWER SHELF		
SSH	SHOWER SOAP HOLDER	(TO BE SELECTED)		
TRH	TOILET ROLL HOLDER	MONDELLA RESONANCE TOILET PAPER HOLDER		
TRL	HEATED TOWEL RAIL	(TO BE SELECTED)		
TRR	TOWEL RING	CAROMA COSMO CHROME TOWEL RING		
WVT	WALL VENT	(TO BE SELECTED)		


- NOTES:

 1. SHOWER RECESS TO BE SEMI FRAMELESS SCREEN, WALLS AND DOOR, WITH CROSS BRACE AT TOP OF SCREEN.

 2. NOGGIN TO BE FITTED BEHIND PLASTER TO SUIT ALL WALL MOUNTED ITEMS.


- ALL ENSUITE ITEMS ARE NOTED TO BE CONFIRMED PRIOR TO COMMENCEMENT OF WORKS.

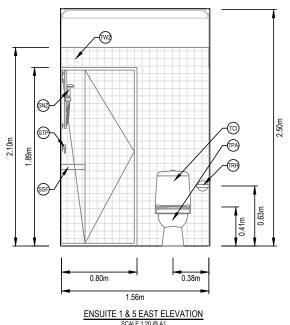


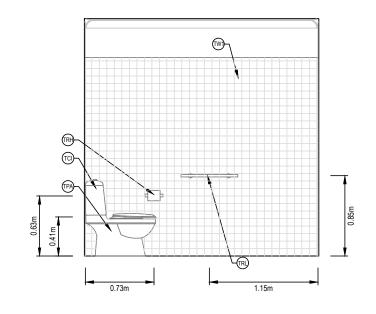

ENSUITE 1 & 5 NORTH ELEVATION


SCALE 1:20 @ A1 SCALE 1:40 @ A3

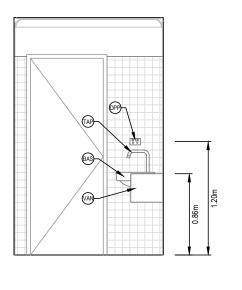

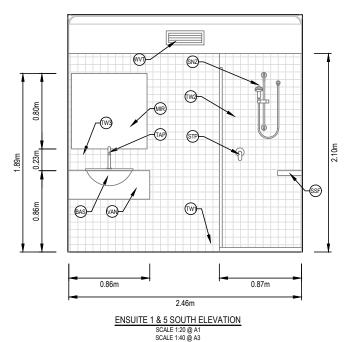


SCALE 1:20 @ A1 SCALE 1:40 @ A3

0.45m

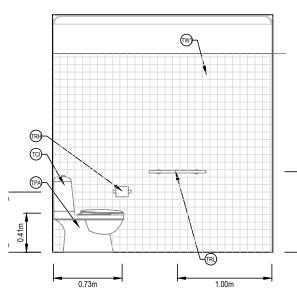

ENSUITE 1 & 5 EAST ELEVATION SCALE 1:20 @ A1 SCALE 1:40 @ A3

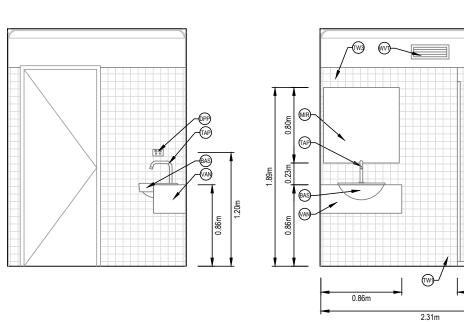

	₩\
041m	
0.73m	1.00m
ENSUITE 2 & 6	NORTH ELEVATION

ENSUITE 2 & 6 EAST ELEVATION

SCALE 1:20 @ A1

SCALE 1:40 @ A3

ENSUITE 2 & 6 SOUTH ELEVATION

SCALE 1:20 @ A1

SCALE 1:40 @ A3

SCALE 1:20 @ A1 SCALE 1:40 @ A3



DESI	SIGN BY: S.Pollard May 2023				
DRA	TED BY: T.Ainsworth M	ay 2023			
	FIED BY:				
AUTH	HORISED BY: G.Ryan R	EG. No.:			
Е	AMENDED AS PER CLIENT REQUEST	14/11/23	TA	SMP	
D	AMENDED AS PER CLIENT REQUEST	01/09/23	TA	SMP	
С	AMENDED AS PER CLIENT REQUEST	02/08/23	TA	SMP	
В	AMENDED AS PER CLIENT REQUEST	13/07/23	TA	SMP	
Α	INITIAL DRAFT	31/05/23	TA	SMP	
REV	AMENDMENTS	DATE	DRN	ENG	

0 0.2 0.4 1:20 @ A1 1:40 @ A3

GMR Engineering Services Koomerang Ski Club **Ensuite Alterations**

0.87m

Site No. 180, Summit Road, Mt Buller

Proposed Strip Plans Drawing No. GMR09001-24.3.22 Revision. E

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0.80m

1.87m ENSUITE 2 & 6 EAST ELEVATION

SCALE 1:20 @ A1

SCALE 1:40 @ A3



PROPOSED ENSUITE FINISHES			
MARK	MEMBER SIZE	REMARK	
FL1	FLOOR TILES	OMNIFORM CHARCOAL TEXTURED	
TW1	150mm HIGH SKIRTING TILES	ENDEARING WHITE SATIN FINISH	
TW2	SHOWER RECESS TILES	ENDEARING WHITE SATIN FINISH	
TW3	SPLASHBACK TILES	ENDEARING WHITE SATIN FINISH	

PROPOSED ENSUITE PLUMBING FIXTURES			
MEMBER SIZE REMARK			
HAND BASIN	REBA GLOSS WHITE ABOVE COUNTER		
CISTERN	(REFER TO PAN)		
PAN	CAROMA LUNA CLEANFLUSH TOILET SUITE		
SHOWER BASE	RECESSED WITH POLY MARBLE FINISH		
	MEMBER SIZE HAND BASIN CISTERN PAN		


PROPOSED ENSUITE FITTINGS			
MARK	MEMBER SIZE	REMARK	
DPP	DOUBLE POWER POINT	(TO BE SELECTED)	
MIR	MIRROR	(TO BE SELECTED)	
SNZ	SHOWER NOZZLE	POSH BRISTOL SINGLE SHOWER RAIL	
STP	SHOWER TAP WARE	GROHE BAUEDGE SHOWER/BATH MIXER	
TAP	BASIN TAP WARE	CAROMA CHROME JADE TOWER BASIN MIXER	
VAN	VANITY CABINET	ALINA FLUTED SCANDI OAK	


	PROPOSED ENSUITE HARDWARE					
MA	RK	MEMBER SIZE	REMARK			
S	SF	SHOWER SHELF	PHEONIX CHROME APLO SHOWER SHELF			
S	SHOWER SOAP HOLDER		(TO BE SELECTED)			
TI	RH	TOILET ROLL HOLDER	MONDELLA RESONANCE TOILET PAPER HOLDER			
T	₹L	HEATED TOWEL RAIL	(TO BE SELECTED)			
TI	TRR TOWEL RING WVT WALL VENT		CAROMA COSMO CHROME TOWEL RING			
W			(TO BE SELECTED)			


- NOTES:

 1. SHOWER RECESS TO BE SEMI FRAMELESS SCREEN, WALLS AND DOOR, WITH CROSS BRACE AT TOP OF SCREEN.

 2. NOGSIN TO BE FITTED BEHIND PLASTER TO SUIT ALL WALL MOUNTED ITEMS.

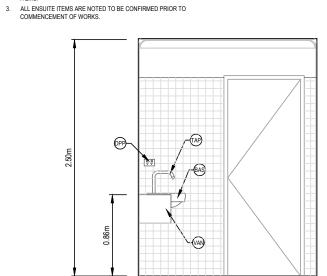

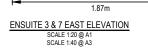


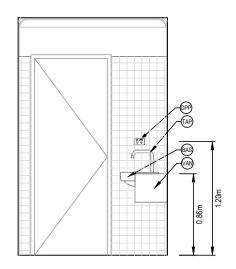

ENSUITE 4 & 8 EAST ELEVATION

SCALE 1:20 @ A1


SCALE 1:40 @ A3

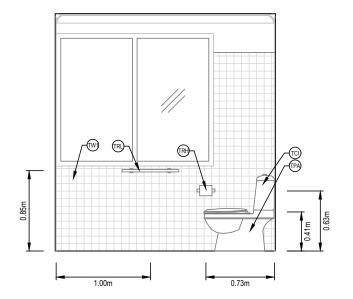


ENSUITE 3 & 7 NORTH ELEVATION

SCALE 1:20 @ A1

SCALE 1:40 @ A3

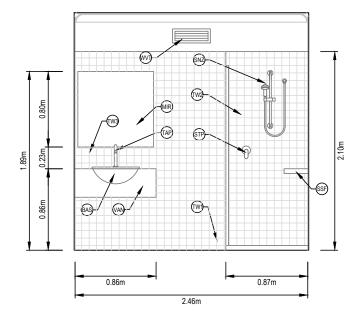


ENSUITE 4 & 8 NORTH ELEVATION
SCALE 1:20 @ A1
SCALE 1:40 @ A3

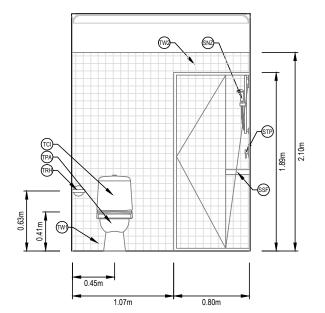

ENSUITE 3 & 7 EAST ELEVATION

SCALE 1:20 @ A1

SCALE 1:40 @ A3

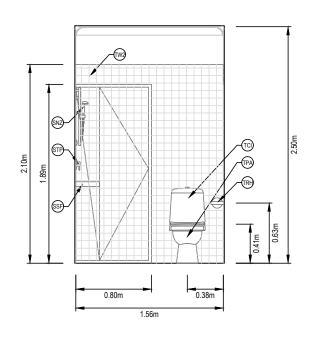


ENSUITE 4 & 8 EAST ELEVATION SCALE 1:20 @ A1 SCALE 1:40 @ A3

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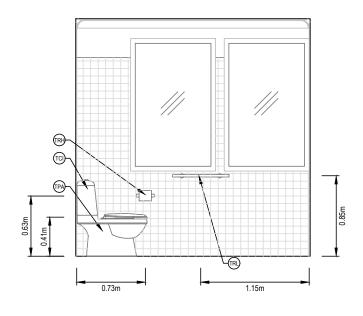
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ENSUITE 3 & 7 SOUTH ELEVATION

SCALE 1:20 @ A1

SCALE 1:40 @ A3

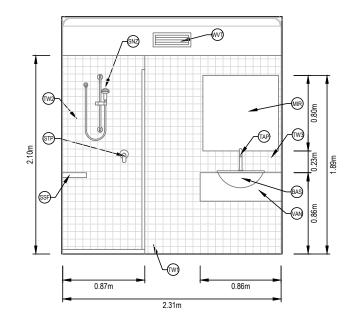

ENSUITE 4 & 8 SOUTH ELEVATION
SCALE 1:20 @ A1
SCALE 1:40 @ A3





AUTH	HORISED BY: G.Ryan RI	REG. No.:		
Е	AMEMDED AS PER CLIENT REQUEST	14/11/23	TA	SMP
D	AMENDED AS PER CLIENT REQUEST	01/09/23	TA	SMP
С	AMENDED AS PER CLIENT REQUEST	02/08/23	TA	SMP
В	AMENDED AS PER CLIENT REQUEST	13/07/23	TA	SMP
Α	INITIAL DRAFT	31/05/23	TA	SMP
REV	AMENDMENTS	DATE	DRN	ENG

May 2023

May 2023



Koomerang Ski Club **Ensuite Alterations**

Site No. 180, Summit Road, Mt Buller

Proposed Strip Plans Drawing No. GMR09001-24.3.23 Revision. E GMR09001-24.3.07 Proposed Strip Plans.dwg

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PROPOSED ENSUITE FINISHES				
MARK	MEMBER SIZE	REMARK		
FL1	FLOOR TILES	OMNIFORM CHARCOAL TEXTURED		
TW1	150mm HIGH SKIRTING TILES	ENDEARING WHITE SATIN FINISH		
TW2	SHOWER RECESS TILES	ENDEARING WHITE SATIN FINISH		
TW3	SPLASHBACK TILES	ENDEARING WHITE SATIN FINISH		

PROPOSED ENSUITE PLUMBING FIXTURES					
MARK	MARK MEMBER SIZE REMARK				
BAS	HAND BASIN	REBA GLOSS WHITE ABOVE COUNTER			
TCI	CISTERN	(REFER TO PAN)			
TPA	PAN	CAROMA LUNA CLEANFLUSH TOILET SUITE			
SHOWER BASE		RECESSED WITH POLY MARBLE FINISH			

	PROPOSED ENSUITE FITTINGS					
	MARK MEMBER SIZE		REMARK			
	DPP DOUBLE POWER POINT		(TO BE SELECTED)			
	MIR MIRROR SNZ SHOWER NOZZLE		(TO BE SELECTED) POSH BRISTOL SINGLE SHOWER RAIL			
	STP	SHOWER TAP WARE	GROHE BAUEDGE SHOWER/BATH MIXER			
	TAP	BASIN TAP WARE	CAROMA CHROME JADE TOWER BASIN MIXER			
	VAN	VANITY CABINET	ALINA FLUTED SCANDI OAK			


PROPOSED ENSUITE HARDWARE					
MARK	MEMBER SIZE	REMARK			
SSF	SHOWER SHELF	PHEONIX CHROME APLO SHOWER SHELF			
SSH	SHOWER SOAP HOLDER	(TO BE SELECTED)			
TRH	TOILET ROLL HOLDER	MONDELLA RESONANCE TOILET PAPER HOLDER			
TRL	HEATED TOWEL RAIL	(TO BE SELECTED)			
TRR	TOWEL RING	CAROMA COSMO CHROME TOWEL RING			
WVT	WALL VENT	(TO BE SELECTED)			

- NOTES:

 1. SHOWER RECESS TO BE SEMI FRAMELESS SCREEN, WALLS AND DOOR, WITH CROSS BRACE AT TOP OF SCREEN.

 2. NOGGIN TO BE FITTED BEHIND PLASTER TO SUIT ALL WALL MOUNTED ITEMS.



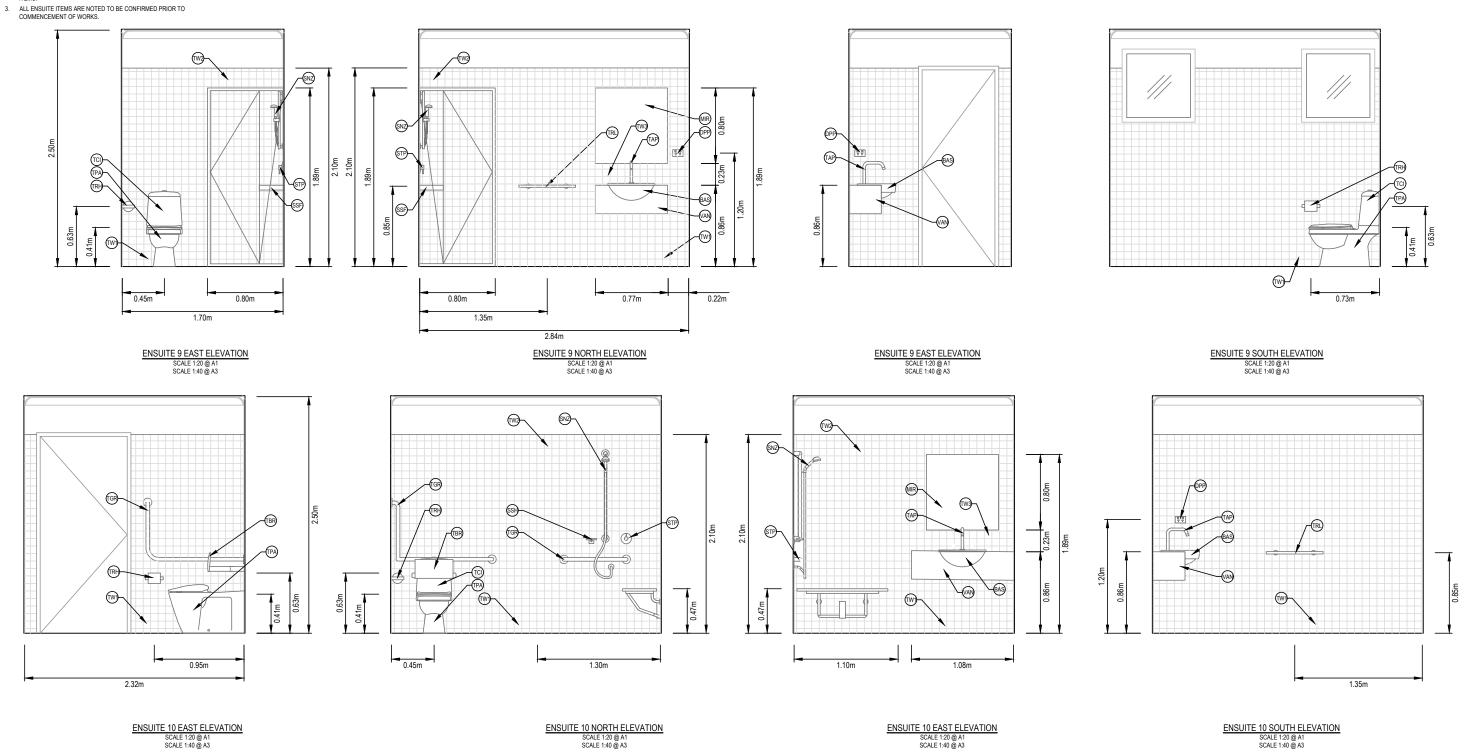





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Ε	AMENDED AS PER CLIENT REQUEST	14/11/23	TA	SMP
D	AMENDED AS PER CLIENT REQUEST	01/09/23	TA	SMP
С	AMENDED AS PER CLIENT REQUEST	02/08/23	TA	SMP
В	AMENDED AS PER CLIENT REQUEST	13/07/23	TA	SMP
Α	INITIAL DRAFT	31/05/23	TA	SMP
REV	AMENDMENTS	DATE	DRN	ENG

May 2023

S.Pollard

DESIGN BY:


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Ensuite Alterations

Site No. 180, Summit Road, Mt Buller

Proposed Strip Plans Drawing No. GMR09001-24.3.24 Revision. E GMR09001-24.3.07 Proposed Strip Plans.dwg



INDICATIVE PLUMBING ARRANGEMENT
SCALE 1:20 @ A1
SCALE 1:40 @ A3

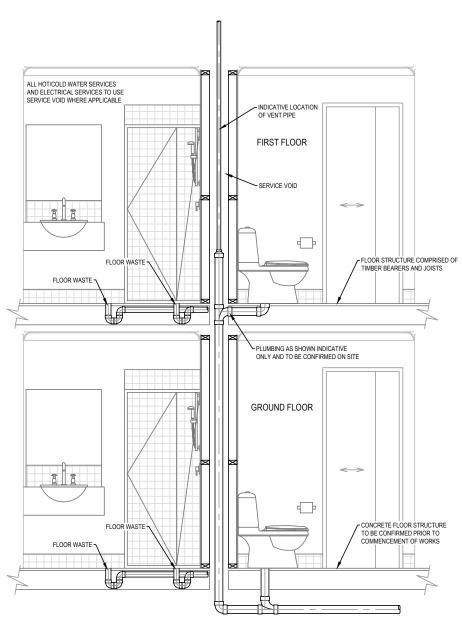



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D	AMENDED AS P	ER CLIENT REQUEST		14/11/23	TA	SMP	
C AMENDED AS PER CLIENT REQUEST 01/09/2		01/09/23	TA	SMP			
В	AMENDED AS PER CLIENT REQUEST			02/08/23	TA	SMP	
Α	INITIAL DRAFT			31/05/23	TA	SMP	
REV		AMENDMENTS		DATE	DRN	ENG	

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SCAL	_		1:20 @ A1 1:40 @ A3

GMR Engineering Services Koomerang Ski Club Ensuite Alterations

Site No. 180, Summit Road, Mt Buller

Proposed Details Drawing No. GMR09001-24.3-25 Revision. D

GENERAL NOTES:

- PRIOR TO SETTING OUT / CONSTRUCTING THESE WORKS THE PROPERTY BOUNDARIES TO BE CONFIRMED BY A LICENSED SURVEYOR (IF REQUIRED).
- 2. THE ALIGNMENT GEOMETRY SHALL BE ADJUSTED TO SUIT. NO LAND ACQUISITION OR PROPERTY ADJUSTMENTS REQUIRED.
- PIT LID LEVELS SHALL MATCH TOP OF ADJACENT SURFACE LEVELS FOR JUNCTION PITS AND GRATED TOP ENTRY PITS. ALL
 PIT LIDS TO MATCH LEVEL AND GRADE OF DESIGN SURFACE IN WHICH LOCATED.
- . THE CONTRACTOR SHALL CONFIRM CONDUIT LOCATION PRIOR TO EXCAVATION AND PLACEMENT.
- THE LOCATION OF UNDERGROUND SERVICES ARE APPROXIMATE ONLY AND THEIR EXACT POSITION AND LEVEL SHOULD BE PROVEN ON SITE PRIOR TO THE COMMENCEMENT OF ANY WORKS.
- 6. STRIP TOPSOIL TO A DEPTH OF 75mm AND STOCKPILE AT AN APPROVED LOCATION FOR LATER REUSE.
- EXCAVATE ALONGSIDE EXISTING JUNCTION PITS & BREAKAWAY SIDE WALL. CONSTRUCT NEW PIT AS DETAILED IN DRAWINGS. REMOVE OFF SITE.
- EXISTING ELECTRICITY MAIN TO BE DEPTHED UPON BEGINNING OF CONTRACT. ELECTRICITY MAIN TO COMPLY WITH AUTHORITY CLEARANCES. CONTRACTOR TO MAKE NECESSARY ADJUSTMENTS TO REQUIREMENTS OF AUTHORITY STANDARDS AND ADJUST IF REQUIRED.
- 9. ELECTRICAL CONTRACTOR TO DISCONNECT AND DISMANTLE EXISTING LIGHTING. STORE OFF SITE AT A LOCATION DIRECTED BY SUPERINTENDENT.
- EXISTING SEWER MAIN AND SERVICES TO BE LOCATED UPON BEGINNING OF CONTRACT. SEWER SERVICES TO COMPLY WITH RELEVANT AUSTRALIAN STANDARD CLEARANCES. CONTRACTOR TO MAKE NECESSARY ADJUSTMENTS TO AUSTRALIAN STANDARDS AND ADJUST IF REQUIRED.
- 10. EXISTING WATER MAIN AND SERVICES TO BE LOCATED UPON BEGINNING OF CONTRACT. WATER SERVICES TO COMPLY WITH RELEVANT AUGMANDAD CLEARANCES, CONTRACTOR TO MAKE NECESSARY ADJUSTMENTS TO AUSTRALIAN STANDARDS AND ADJUST IF REQUIRED.
- EXISTING TELECOMMUNICATIONS MAIN AND SERVICES TO BE LOCATED UPON BEGINNING OF CONTRACT.
 TELECOMMUNICATIONS SERVICES TO COMPLY WITH RELEVANT AUSTRALIAN STANDARD CLEARANCES. CONTRACTOR TO
 MAKE NECESSARY ADJUSTMENTS TO AUSTRALIAN STANDARDS AND ADJUST IF REQUIRED.
- EXISTING GAS MAIN AND SERVICES TO BE LOCATED UPON BEGINNING OF CONTRACT. GAS SERVICES TO COMPLY WITH RELEVANT AUSTRALIAN STANDARD CLEARANCES. CONTRACTOR TO MAKE NECESSARY ADJUSTMENTS TO AUSTRALIAN STANDARDS AND ADJUST IF REQUIRED.
- EXCAVATED MATERIAL TO BE STORED AT AN APPROVED LOCATION AND RECOVERED FOR REUSE (IF SUITABLE) AFTER TESTING AS APPROVED BY SUPERINTENDENT.
- 12. RECOVER EXISTING SUITABLE TOPSOIL, SCREEN, SPREAD AND COMPACT TO DESIGN LEVELS AS SPECIFIED.
- ON COMPLETION OF WORKS SPREAD RECOVERED TOPSOIL TO ALL LANDSCAPED AREAS. ENSURE SURFACES ARE FREELY DRAINING, EVENLY GRADED AND HAVE SMOOTH INTERFACE.

STRUCTURAL STEELWORK NOTES:

- ALL WORKMANSHIP AND MATERIALS SHALL BE IN ACCORDANCE WITH AS 4100.
- 2. ALL HOT ROLLED SECTIONS ARE TO BE GRADE 300 PLUS.
- 3. ALL STRUCTURAL HOLLOW SECTIONS ARE TO BE GRADE 350 MPA
- WELDING SHALL BE PERFORMED BY AN EXPERIENCED OPERATOR IN ACCORDANCE WITH AS 1554, INSPECTED AND CERTIFIED BY A QUALIFIED PERSON AS DESCRIBED IN AS 2214.
- 5. THE BOLTING PROCEDURES ARE TO BE IN ACCORDANCE WITH AS 1111 AND AS 1252.
- 6. THE CONTRACTOR SHALL PROVIDE TEMPORARY BRACING AND LEAVE IN PLACE UNTIL PERMANENT BRACING ELEMENTS ARE CONSTRUCTED. SUCH TEMPORARY BRACING AS IS NECESSARY TO STABILISE THE STRUCTURE.
- THE ENDS OF ALL HOLLOW SECTION MEMBERS ARE TO BE SEALED WITH NOMINAL THICKNESS PLATES AND CONTINUOUS FILLET WELD UNLESS OTHERWISE SHOWN.
- UNLESS OTHERWISE SPECIFIED STEELWORK SHALL BE PAINTED ONE SHOP COAT OF RED OXIDE ZINC PHOSPHATE PRIMER. MEMBERS ENCASED IN CONCRETE, FIRE SPRAYED OR FRICTION GRIP BOLTED CONNECTIONS MUST NOT BE PAINTED.
- 9. PAINTING, AS SPECIFIED BY THE PRINCIPAL, SHALL BE IN ACCORDANCE WITH AS 2312, TO SUIT SITE EXPOSURE CONDITIONS
- 10. EXCEPT WHERE OTHERWISE SHOWN, WELDS ARE TO BE 6mm CONTINUOUS FILLET WELDS. ALL WELDS ARE TO BE STRUCTURAL PURPOSE UN O
- 11. UNLESS OTHERWISE SHOWN, PROVIDE SINGLE LINE OF BOLTS CLEAT CONNECTIONS, 10mm CLEAT PLATE, 6mm CONTINUOUS FILLET WELD AND M20 8 &IS BOLTS. PROVIDE 2 NO. BOLTS TO MEMBERS 200mm DEEP & LESS. A.I.S.C. STANDARDIZED STRUCTURAL CONNECTIONS.
- 12. REMOVE ALL BURS, SHARP EDGES, DAGS, SLAG, DUST, RUST, DIRT, MILL SCALE AND OTHER DEBRIS.

TYPICAL STEEL CONNECTION NOTES:

- 1. ALL PLATES AND FLATS SHALL BE GRADE 350 AND SHALL BE 10mm THK (MIN) UNO.
- 2. ALL WELDS SHALL BE 6CFW ALL AROUND, BOTHSIDES UNO.
- 3. ALL BOLTS SHALL BE M16 8.8S UNO.
- ALL STEEL CONNECTIONS SHALL BE GALVANISED
 PROVIDE A MINIMUM OF TWO BOLTS PER FIXING LINO.
- PROVIDE A MINIMUM OF TWO BOLTS PER FIXING UNC
- . WHERE OVERSIZE HOLES HAVE BEEN USED FOR ERECTION TOLERANCE SITE WELD MATING PLATE TOGETHER WITH 100mn LENGTH OF 6CFW (MIN) AFTER BOLTING. MAKE GOOD ALL DAMAGED PAINTWORK.

DEFLECTION MANAGEMENT DURING CONSTRUCTION NOTES:

- DURING ERECTION PROVISION SHALL BE MADE TO LIMIT DEFLECTIONS TO DEAD LOADS ONLY. THE CONSTRUCTOR SHALL ENSURE THE STRUCTURE IS ADEQUATELY SUPPORTED WITH TEMPORARY PROPS AND FALSEWORK DURING CONSTRUCTION/ERECTION TO CONTROL DEFLECTIONS.
- NO TEMPORARY CONSTRUCTION LOADS, PACKS OF MATERIALS OR OTHER SURCHARGES SHALL BE IMPOSED UPON THE STRUCTURE DURING ERECTION.
- THE CONSTRUCTOR SHALL WARRANTEE THAT THE DEFLECTIONS OF PRINCIPAL MEMBERS UPON COMPLETION DO NOT EXCEED THE DESIGNERS STATED "DEAD LOAD DEFLECTION".

TIMBER NOTES:

- ALL TIMBER SHALL BE NEW, UNLESS AGREED OTHERWISE AND SHALL BE SELECT GRADE ONLY AND SHALL BE FREE FROM DEFECTS, GUM VEINS, SHAKES, SPLITS, CRACKS AND TWISTS IN ACCORDANCE WITH RELEVANT AUSTRALIAN STANDARDS
- ALL STRUCTURAL TIMBER TO BE GRADED, DESIGNED AND LOADED TO BE IN ACCORDANCE WITH AS1720, AS1684, AS2082, AS2858, AS3818 AND OTHER RELEVANT AUSTRALIAN STANDARDS.
- ALL STRUCTURAL PLYWOOD TO BE IN ACCORDANCE WITH AS2269, AS2754 AND OTHER RELEVANT AUSTRALIAN STANDARDS.
- ALL STRUCTURAL GLUED LAMINATED TIMBER TO BE IN ACCORADNCE WITH AS1328 AND OTHER RELEVANT AUSTRALIAN STANDARDS.
- FIELD CUTTING, DRILLING OR FABRICATION SHOULD BE DONE AWAY FROM THE RIVER & OTHER SENSITIVE AREAS, WHERE PRACTICABLE. ALL WASTE SHALL BE COLLECTED & DISPOSED OF APPROPRIATELY & ON A REGULAR BASIS.
- ALL SAWN TIMBER SHALL BE OB, NOT DRESSED.
- 7. ALL EXPOSED SURFACES SHALL HAVE ARRASES REMOVED, AND SHALL BE MADE SPLINTER FREE AND ROUGH SANDED
- A MINIMUM OF TWO APPLICATIONS OF COPPER NAPTHENATE SOLUTION IS TO BE APPLIED TO ALL IN-SITU TIMBER IN
 ACCORDANCE WITH RELEVANT AUSTRALIAN STANDARDS TO PROTECT THE TIMBER AGAINST FUNGAL DECAY AND BORERS
- COPPER NAPTHENATE HAS BEEN DEEMED NON ENVIRONMENTALLY HAZARDOUS AS OPPOSED TO THE CONVENTIONAL CCA (COPPER CHROMIUM ARSENIC) TREATMENT. THE ACTIVE CONSTITUENT IN COPPER NAPTHENATE IS EXEMPT FROM THE POISON SCHEDULING UNDER THE NATIONAL HEALTH AND MEDICAL RESEARCH COUNCIL'S UNIFORM POISON STANDARD (1997).
- 10. ALL REPLACEMENT TIMBERS SHALL HAVE SAPWOOD REMOVED PRIOR TO TREATMENT & BE PRE-TREATED WITH AN APPROVED PRESERVATIVE. BEING NON-TOXIC AND CERTIFIED SUITABLE FOR USE IN A POTABLE WATER CATCHMENT ENVIRONMENT. AMATERIAL SAFETY DATA SHEET SHALL BE PROVIDED FROM THE SUPPLIER CONFIRMING THE SUITABILITY OF THE MATERIAL PRIOR TO USE. PRIOR TO TREATMENT THE WOOD SHALL BE INSPECTED TO ENSURE IT IS REASONABLY CLEAN AND FREE OF DIRT AND SAWDUST. A MINIMUM OF TWO APPLICATIONS OF COPPER PAPTHENATE, ON BEFORE INSTALLATION AND THE SECOND AFTER ASSEMBLY WILL BE APPLIED BY HAND, NO SPRAYS WILL SHALL BE USED.
- 11. ALL END GRAINS AND FRESHLY CUT OR EXPOSED INNER SURFACES OF ANY CHECKOUTS, MORTICES, REBATES OR HOLES DRILLED THOUGH OR INTO TIMBER ELEMENTS SHALL BE TREATED WITH AT LEAST TWO APPLICATIONS OF HOT PETROLEUM JELLY, IMMEDIATELY AFTER INSTALLATION AND WHERE POSSIBLE A PVC LAYER SHOULD BE PLACED BETWEEN THE GROUND AND THE TIMBERS WHERE THEY COME INTO CONTACT AT GROUND LEVEL.
- 12. MEMBERS ENCASED IN CONCRETE, FIRE SPRAYED OR FRICTION GRIP BOLTED CONNECTIONS MUST NOT BE PAINTED.
- 13. ALL SUPPORTING SURFACES WILL HAVE NEW DPC THROUGHOUT. DPC SHALL BE 3mm BITUMINOUS FELT, MALTHOID AND SHALL DRAPE OVER EACH OBJECT AT LEAST 20mm ALONG THE EDGES OF THE OBJECT BEING PROTECTED. EXPOSED STRINGERS AND CROSS BEAMS WILL ALSO BE FITTED UTHIT DPC AND ADDITIONAL 1.4mm THICK GALVANISED STEEL SHEETING FITTED OVER THE DPC. SHEETING WILL BE ATTACHED TO THE ELEMENT IT IS PROTECTING TO PREVENT IT BEING DISLODGED.
- 14. CARE SHALL BE TAKEN TO AVOID PRESERVATIVE RESIDUES ENTERING THE WATERWAYS OR SPILLAGES ON THE GROUND OR
- 15. A VISUAL INSPECTION SHALL BE PERFORMED TO VERIFY THE TREATED PRODUCT MEETS THE CRITERIA SPECIFIED ABOVE.

CARTER HOLT HARVEY TIMBER NOTES:

- ALL CARTER HOLT HARVEY TIMBER SECTIONS WILL COMPLY WITH ACCORDANCE TO AS1328.1, AS1604, AS1684, AS1720.1, AS 366.1 & AS4357.
- 2. FINISHINGS AND SURFACE COATING OF ALL CARTER HOLT HARVEY TIMBER SECTION SHALL COMPLY WITH CARTER HOLT HARVEY TIMBER TECHNICAL SPECIFICATIONS
- STORAGE AND HANDLING OF ALL CARTER HOLT HARVEY TIMBER SECTIONS SHALL STRICTLY COMPLY WITH CARTER HOLT HARVEY TIMBER TECHNICAL SPECIFICATIONS.
- ALL CARTER HOLT HARVEY TIMBER PRODUCTS TREATED TO H3 THAT HAVE BEEN MODIFIED IN THE FORM OF CUTTING, REBATING OR DRILLING MUST BE RESEALED WITH A SUITABLE SITE APPLICATION OF TIMBER PRESERVATIVE.

STUD WALL NOTES:

F5 (OR MGP10) PINE STUD WALLS:

- 1. COMMON STUDS 90 x 35mm PINE @ 450 CTRS UNO.
- JAMB STUDS 90 x 45mm PINE UNO.
- DOUBLE STUDS USED AT SUPPORTS FOR ALL BEAMS AND LINTELS OVER LARGE OPENINGS IE. UP TO 3,000mm. STEEL POSTS
 FOR SPANS OVER 3,000mm. 1 INO
- 4. ALL WALLS TO HAVE 90 x 45mm PINE PLATES TOP AND BOTTOM UNO.
- 5. ALL LOAD BEARING WALLS TO HAVE DOUBLE TOP PLATES UNDER TRUSSES / RAFTERS UNO.
- 6. ALL TRUSSES / RAFTERS SHALL BE LOCATED OVER OR ADJACENT TO STUDS UNO.
- PLYWOOD BRACING TO BE INSTALLED AS PER AS1684.2 TABLE 8.18 PAT G TO ALL INDEPENDENT STUD WALLS.

WALL NOGGINGS:

8. MAXIMUM 1,350mm VERTICAL SPACING BETWEEN PLATES AND NOGGINGS - UNO

INTERNAL CLADDING & FINISHES:

- WALLS 10mm PLASTERBOARD LINII
- CEILINGS 10mm UNISPAN OR SIMILAR APPROVED PLASTERBOARD.
 - WET AREAS WATER RESISTANT GRADE. THE WALL SURFACE OF A SHOWER ENCLOSURE SHALL BE IMPERVIOUS TO WATER TO A HEIGHT OF 1,800mm ABOVE THE FLOOR AND IMMEDIATELY ADJACENT OR BEHIND A BATH, BASIN OR SINK OR A HEIGHT OF NO LESS THAN 150mm ABOVE THE FIXTURES IN ACCORDANCE WITH PART 3.8.1 OF BUILDING CODE OF AUSTRALIA.

TILING / VINYL NOTES:

- 1. FLOOR FINISHES AS INDICATED ON FLOOR PLANS. REFER WET AREA DETAILS FOR COVING / SKIRTING REQUIREMENTS
- 2. WALL TILES TO SHOWER WALLS TO A MINIMUM HEIGHT OF 1800mm & ABOVE BASINS, TROUGHS & BATHS TO A HEIGHT OF 600mm UNLESS NOTED OTHERWISE, REFER TO WET AREA DETAILS

IMPERVIOUS FINISHES:

- 1. FLOOR TILES TO ALL WET AREAS (ALL BATHROOMS, LAUNDRIES AND WC'S)
- 2. ALL WET AREAS TO BE WATERPROOFED IN ACCORDANCE WITH AS 3740 AND CLAUSE 3.8.1.2 NCC 2019.
- A 3-SMM WIDE FLEXIBLE SEALANT IS TO BE PROVIDED EXTERNALLY TO ALL WALL & FLOOR
 JUNCTIONS AND JOINTS TO WET AREAS TYPICALLY THROUGHOUT EG. WITHIN SHOWER
 RECESSES, AROUND SHOWER BASE, AROUND BATH/SPA TUBS, BEHIND SPLASH BACKS, ETC
- PROVIDE AN IMPERVIOUS SUBSTRATE AND SELECT SURFACE FINISH TO FLOORS WITHIN 1500MM OF AN UNENCLOSED SHOWER AND SAME TO WALLS AT 1800MM ABOVE FLOORS.


MECHANICAL VENTILATION:

- ALL MECHANICAL EXHAUST VENTILATION TO COMPLY WITH PART F6 & F8D4 OF VOLUME 1 BUILDING CODE OF AUSTRALIA, AS 1668.2 AND ASINZS 3666.1.
- 2. LAUNDRIES, BATHROOMS, ENSUITES AND POWDER ROOMS THAT ARE NOT NATURALLY VENTILATED, AS WELL AS KITCHEN RANGEHOODS, SHALL BE PROVIDED WITH MECHANICAL VENTILATION DUCTED TO THE EXTERNAL ENVIRONMENT.

PLUMBING & SEWER NOTES:

- ALL WATER SERVICES FITTINGS, CONNECTIONS, TESTING AND COMMISSIONING WORKS TO COMPLY WITH THE RELEVANT SECTIONS OF BUILDING CODE OF AUSTRALIA AND AS/NZS 3500.1:2021 PLUMBING AND DRAINAGE PART 1: WATER SERVICES AND OTHER RELEVANT AUSTRALIAN STANDARDS.
- ALL SEWER, SANITARY PLUMBING AND DRAINAGE FITTINGS, CONNECTIONS, TESTING AND COMMISSIONING WORKS TO
 COMPLY WITH THE RELEVANT SECTIONS OF BUILDING COOF AUSTRALIA, ASINZS 3600.22021 PLUMBING AND DRAINAGE
 PART 2: SANITARY PLUMBING AND DRAINAGE AND OTHER RELEVANT AUSTRALIAN STANDARDS.
- 3. ALL MATERIALS AND PRODUCTS SHALL BE SELECTED TO ENSURE THEY ARE FIT FOR THEIR INTENDED PURPOSE.
- 4. ALL PIPES, FITTINGS AND BENDS SHALL BE INSPECTED FOR DAMAGE PRIOR TO COMMISSIONING AND REPLACED AS REQUIRED.



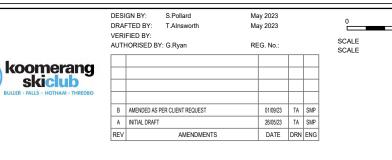

GMR Engineering Services
Koomerang Ski Club

Site No. 180, Summit Road, Mt Buller

Ensuite Alterations

Standard Notes
Drawing No. GMR09001-24.3.26

Revision. B She GMR09001-24.3.09 Standard Notes.dwg

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REDUCED SCALE